PHASE 2 - HISTORIC STABILIZATION

BANDERA COUNTY VISITOR CENTER

100% CONSTRUCTION DOCUMENT



<u>OWNERS</u>

www.banderacounty.org

BANDERA COUNTY 500 MAIN STREET BANDERA, TX 78003 CONTACTS: HONORABLE JUDGE RICHARD EVANS **COMMISSIONER JACK MOSELEY** EMAIL: countyjudge@banderacounty.org jmoseley@banderacounty.org PH: JACK MOSELEY - (830) 522-1500

ARCHITECT


FISHER HECK ARCHITECTS 915 S. ST. MARY'S STREET SAN ANTONIO, TX 78205 PH: (210) 299-1500 CONTACT: MARK NAVARRO EMAIL: mnavarro@fisherheck.com www.fisherheck.com


BANDERA COUNTY VISITOR CENTER

PROJECT NO: 2301 A1 1 RE-ISSUE


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LOCATION MAPS



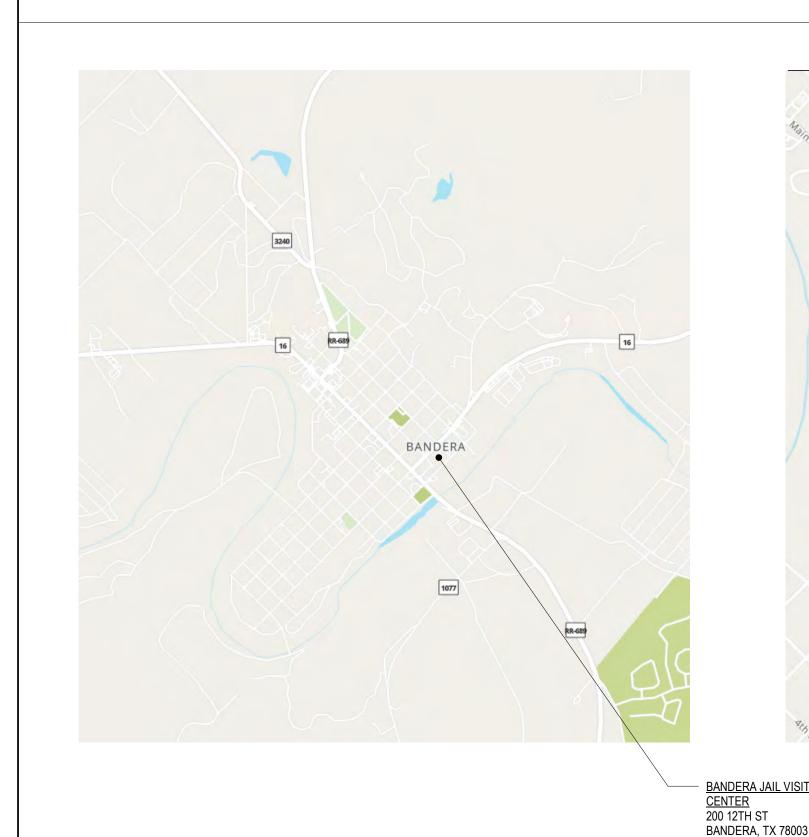

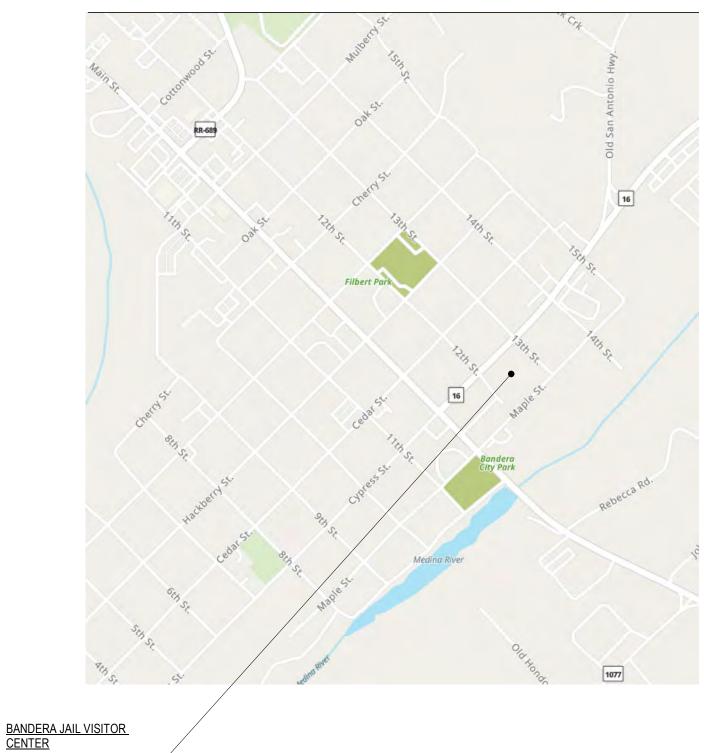CONSTRUCTION SITE PLAN

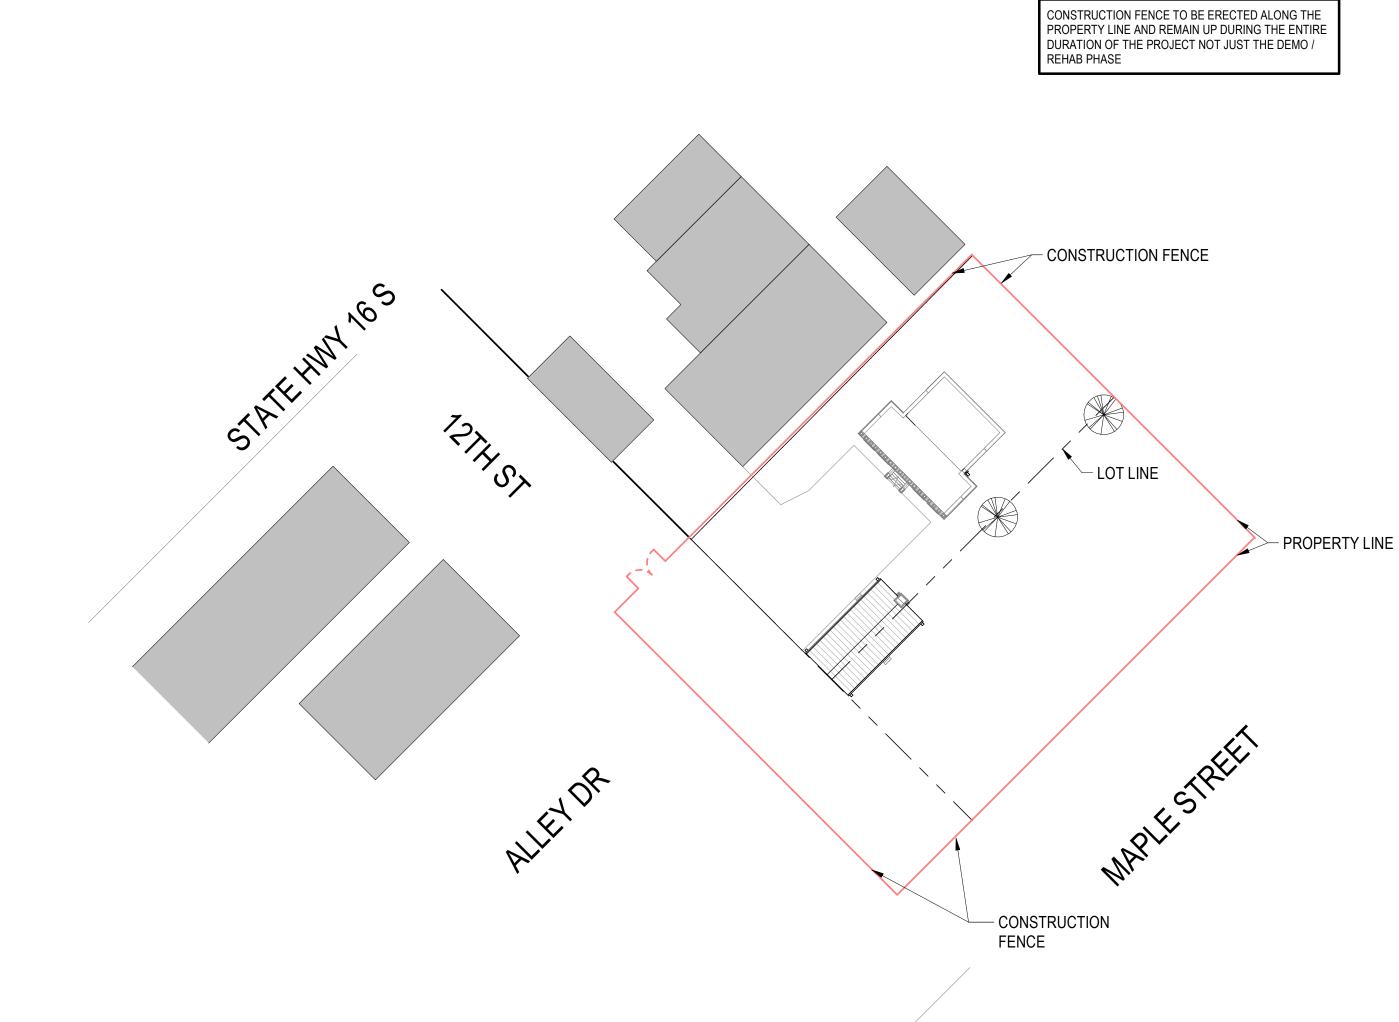

DRAWING INDEX

GENERAL

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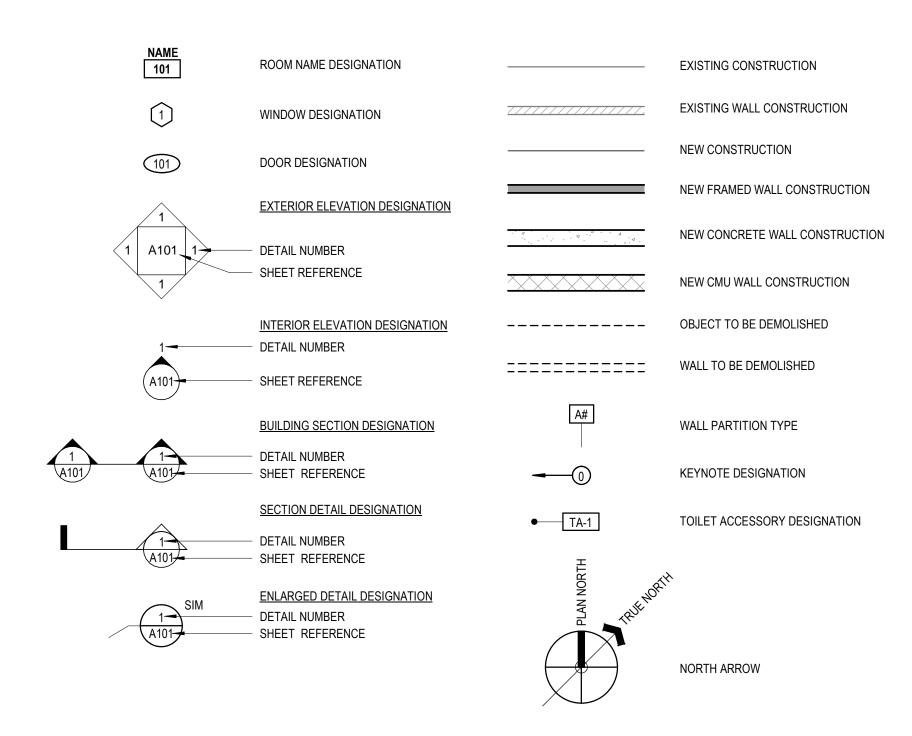
DEMOLITION

DEMOLITION PLANS - 1877 COURTHOUSE DEMOLITION PLANS - 1881 JAIL

ARCHITECTURAL

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A-100	REHABILITATION PLANS - 1877 COURTHOUSE
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ABBREVIATIONS



GENERAL NOTES

1.	THESE DOCUMENTS SHOULD NOT BE CONSIDERED AS A SURVEY OF EXISTING CONDITIONS. THE GENERAL CONTRACTOR SHALL FIELD VERIFY ALL EXISTING
	DIMENSIONS AND CONDITIONS, AND NOTIFY THE ARCHITECT OF ANY DISCREPANCIES OR OMISSIONS BETWEEN THE CONTRACT DOCUMENTS AND FIELD CONDITION
	BEFORE COMMENCING ANY WORK AND REQUEST CLARIFICATION.
2.	ALL NOTES REFERENCE NEW WORK UNLESS NOTED AS EXISTING.

REMOVE ALL DEBRIS, RUBBISH AND OTHER MATERIALS RESULTING FROM DEMOLITION.

STATE, AND FEDERAL CONSTRUCTION SAFETY AND SANITARY LAWS, CODES, STATUTES, AND ORDINANCES.

PATCH ALL SURFACES AND AREAS AFFECTED BY DEMOLITION AND PREPARE FOR REHABILITATION. THE EXTENT OF DEMOLITION WORK IS SHOWN ON THE DRAWINGS. IT IS NOT POSSIBLE TO SHOW REQUIRED DEMOLITION, REMODELING AND PATCHING IN EVERY DETAIL. THE CONTRACTOR SHALL VISIT THE FACILITY TO DETERMINE THE EXTENT OF DEMOLITION AND REMODELING WORK, AND TO FAMILIARIZE HIMSELF WITH THE CONDITIONS UNDER WHICH THE WORK WILL BE PERFORMED. NO ADDITIONAL COMPENSATION WILL BE ALLOWED FOR ADDITIONAL WORK REQUIRED AS A RESULT OF

THE WORK INDICATED HEREIN OR FOR PATCHING REQUIRED AS A RESULT OF NEW WORK, REMODELING OR DEMOLITION. 5. IT IS NOT POSSIBLE FOR THE ARCHITECT TO NOTE ALL DETERIORATED CONDITIONS. THE CONTRACTOR SHALL VISIT THE FACILITY TO DETERMINE THE CONDITION

ITEMS INDICATED FOR SALVAGE BY OWNER SHALL BE REMOVED BY THE CONTRACTOR AND DELIVERED TO OWNER'S DESIGNATED STORAGE AREA.

10. REPAIR, AT NO COST TO THE OWNER, DAMAGE CAUSED TO ADJACENT AREAS, MATERIALS AND EQUIPMENT BY DEMOLITION AND NEW CONSTRUCTION OPERATIONS.

12. THE CONTRACTOR IS RESPONSIBLE FOR DETERMINING SHORING REQUIREMENTS IF NECESSARY 13. THE GENERAL AND SUBCONTRACTOR(S) MUST COMPLY WITH ALL RULES AND REGULATIONS OF AGENCIES HAVING JURISDICTION AND SHALL CONFORM TO ALL CITY,

CODE INFO & ANALYSIS

APPLICABLE CODES AND STANDARDS:

APPLICABLE CODES AND STANDARDS:

THIS PROJECT IS IN THE CITY OF BANDERA, TEXAS. THE CITY OF BANDERA CURRENTLY HAS ADOPTED THE FOLLOWING CODES WITH LOCAL AMENDMENTS:

• 2018 INTERNATIONAL FIRE CODE • 2018 INTERNATIONAL MECHANICAL CODE

1877 COURTHOUSE:

OCCUPANCY CLASSIFICATION: • ALTERATION - LEVEL 3

AREAS:ACTUAL TOTAL AREA (EXISTING)

• 2018 NATIONAL ELECTRICAL CODE 2018 INTERNATIONAL ENERGY CONSERVATION CODE

OCCUPANCY CLASSIFICATION: CLASSIFICATION OF WORK:

ACTUAL TOTAL AREA (EXISTING) - 2,230 Si

CVMBOIC

	SYM	BOL	.S
	AND AT POUND, NUMBER CENTER LINE	MAS MAX MDP MECH MED	MASONRY MAXIMUM MAIN DISTRIBUTION PANEL MECHANICAL MEDIUM
ACT ADDN. ADDN'L ADJ AFF AHU	ACOUSTICAL CEILING ADDITION ADDITIONAL ADJUSTABLE ABOVE FINISHED FLOORS AIR HANDLING UNIT	MFR MH MN MISC MO MTD	MANUFACTURER MANHOLE MINIMUM MISCELLANEOUS MASONRY OPENING MOUNTED
ALT ALUM APPROX ARCH	ALTERNATE ALUMINUM APPROXIMATE ARCHITECT, ARCHITECTURE	MTL N NIC NO	METAL NORTH NOT IN CONTRACT NUMBER
3.O. BCS BD BLDG	BOTTOM OF BABY CHANGING STATION BOARD BUILDING	NOM NTS	NOMINAL NOT TO SCALE ON CENTER
CFM CFT CJ CFA	CUBIC FEET PER MINUTE CERAMIC FLOOR TILE CONTROL JOINT CLEAR FLOOR AREA	OD O.H. OPP OZ	OUTSIDE DIAMETER OPPOSITE HAND OPPOSITE OUNCE
CLLG CLR CMU CO COL	CEILING CLEAR CONCRETE MASONRY UNIT CLEAN OUT COLUMN	P PCF PERF PL PLAM	PAINT POUNDS PER CUBIC FOOT PERFORATED PLATE PLASTIC LAMINATE
CONC CONST CONT CPT CPTB	CONCRETE CONSTRUCTION-CONTINUOUS CARPET CARPET BASE	PLUM PLF PLYWD PR	PLUMBING POUNDS PER LINEAR FOOT PLYWOOD PAIR
CTB CWT CU CUH CW	CERAMIC TILE BASE CERAMIC WALL TILE CONDENSING UNIT CABINET UNIT HEATER COLD WATER	PSF PSI PT PTD PVC	POUNDS PER SQUARE FOOT POUNDS PER SQUARE INCH POINT PAINTED POLYVINYL CHLORIDE
OTL DIA DIM DISP	DETAIL DIAMETER DIMENSION DISPENSER	PVMT QT QTY	PAVEMENT QUARRY TILE QUANTITY
ON OS OW OWG	DOWN DOWNSPOUT DUMB WAITER DRAWING	R RB RCP RD RE:	RISER, RADIUS RUBBER BASE BOARD REFLECTED CEILING PLAN ROOF DRAIN REFER TO
EA EJ ELEV	EAST EACH EXPANSION JOINT ELEVATION	REF REINF REQ REV RF	REFRIGERATOR REINFORCE (D) REQUIRED REVISIONS
ELEC EP EQ EQUIP EWC EWH	ELECTRICAL ELECTRICAL PANEL EQUAL EQUIPMENT ELECTRIC WATER COOLER ELECTRIC WATER HEATER	RH RM RO ROW RS	RESILIENT FLOORING RIGHT HAND ROOM ROUGH OPENING RIGHT OF WAY ROUGH SAWN
EXH EXP EXT	EXHAUST EXPANSION EXTERIOR FIRE ALARM	RTU S SAN SAT	ROOF TOP UNIT SOUTH SANITARY SUSPENDED ACOUSTICAL TILE
FACP FD FE FEC FF	FIRE ALARM CONTROL PANEL FLOOR DRAIN, FIRE DAMPER FIRE EXTINGUISHER FIRE EXTINGUISHER CABINET FINISHED FLOOR	SC SCHED SECT SERV SF	SOLID CORE / OVERFLOW SCUPPER SCHEDULE SECTION SERVICE SQUARE FEET
G IN ILR('G) IT	FINISHED GRADE FINISH(ED) FLOOR(ING) FACE OF FOOT, FEET	SIM SPEC SQ SS ST	SIMILAR SPECIFICATIONS SQUARE STAINLESS STEEL STORM
TTG FURN FWC	FOOTING FURNISH(ED) FABRIC WALL COVERING GAUGE	STD STL STRUCT SUSP SWG	STANDARD STEEL STRUCTURAL SUSPENDED STANDARD WIRE GAUGE
GALV GC GFI GL GYP	GALVANIZED GENERAL CONTRACTOR GROUND FAULT INTERRUPTER GLASS GYPSUM	SYM T T&B T&G	SYMMETRICAL TREAD TOP AND BOTTOM TONGUE AND GROOVE
HB HC HWD HID	HOSE BIBB HOLLOW CORE HARDWOOD HIGH INTENSITY DISCHARGE	TEL TEMP THK T.O. TYP	TELEPHONE TEMPERATURE, TEMPERED THICK (NESS) TOP OF TYPICAL
IM IORIZ IVAC IW	HOLLOW METAL HORIZONTAL HEAT, VENT, A/C HOT WATER	TV UG UH UNO	TELEVISION UNDERGROUND UNIT HEATER UNLESS NOTED OTHERWISE
O NCL NT NV	INSIDE DIAMETER INCLUDING INTERIOR INVERT	VB VCT VERT	VINYL BASE BOARD VINYL COMPOSITION TILE VERTICAL
B ST	JUNCTION BOX JOIST	VIF VWC W	VERIFY IN FIELD VINYL WALL COVERING WEST
AM AV	KIP (1,000 POUNDS) LAMINATED LAVATORY	W/ W/O WB WC	WITH WITHOUT WOOD BASE BOARD WATER CLOSET
AV B F H L L	POUND LINEAR FEET LEFT HAND LIVE LOAD LONG LEG HORIZONTAL	WD WH WP WT WWF	WATER CLOSET WOOD WATER HEATER WATERPROOF, WORK POINT WEIGHT WELDED WIRE FABRIC
LV .P	LONG LEG VERTICAL LIGHTNING PANEL	YD	YARD

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INFORMATION

PROJECT

GENERAL

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COUNTY VISITOR CENTER


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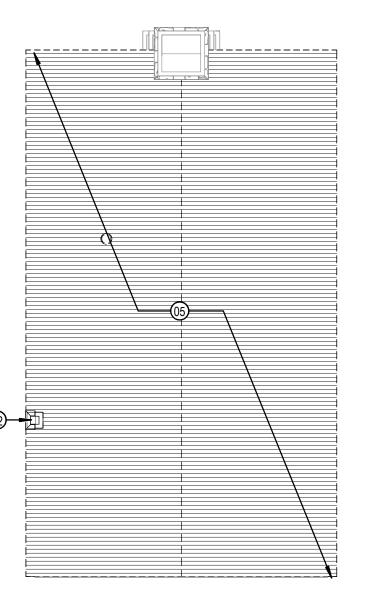
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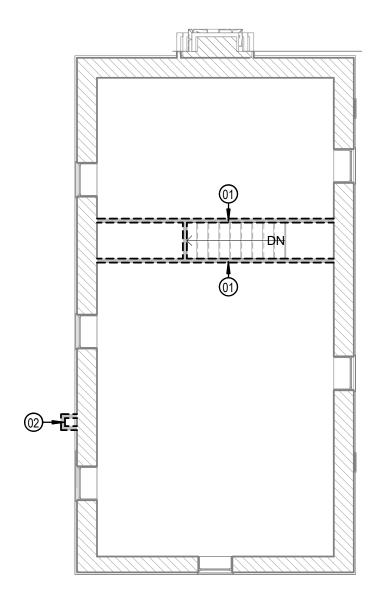
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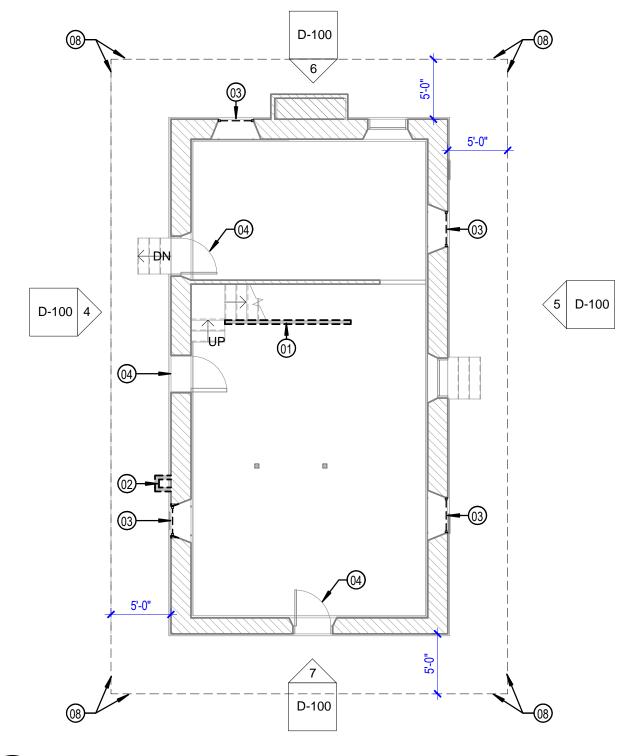




1877 COURTHOUSE-DEMOLITION-ROOF



2 1877 COURTHOUSE-DEMOLITION-SECOND FLOOR

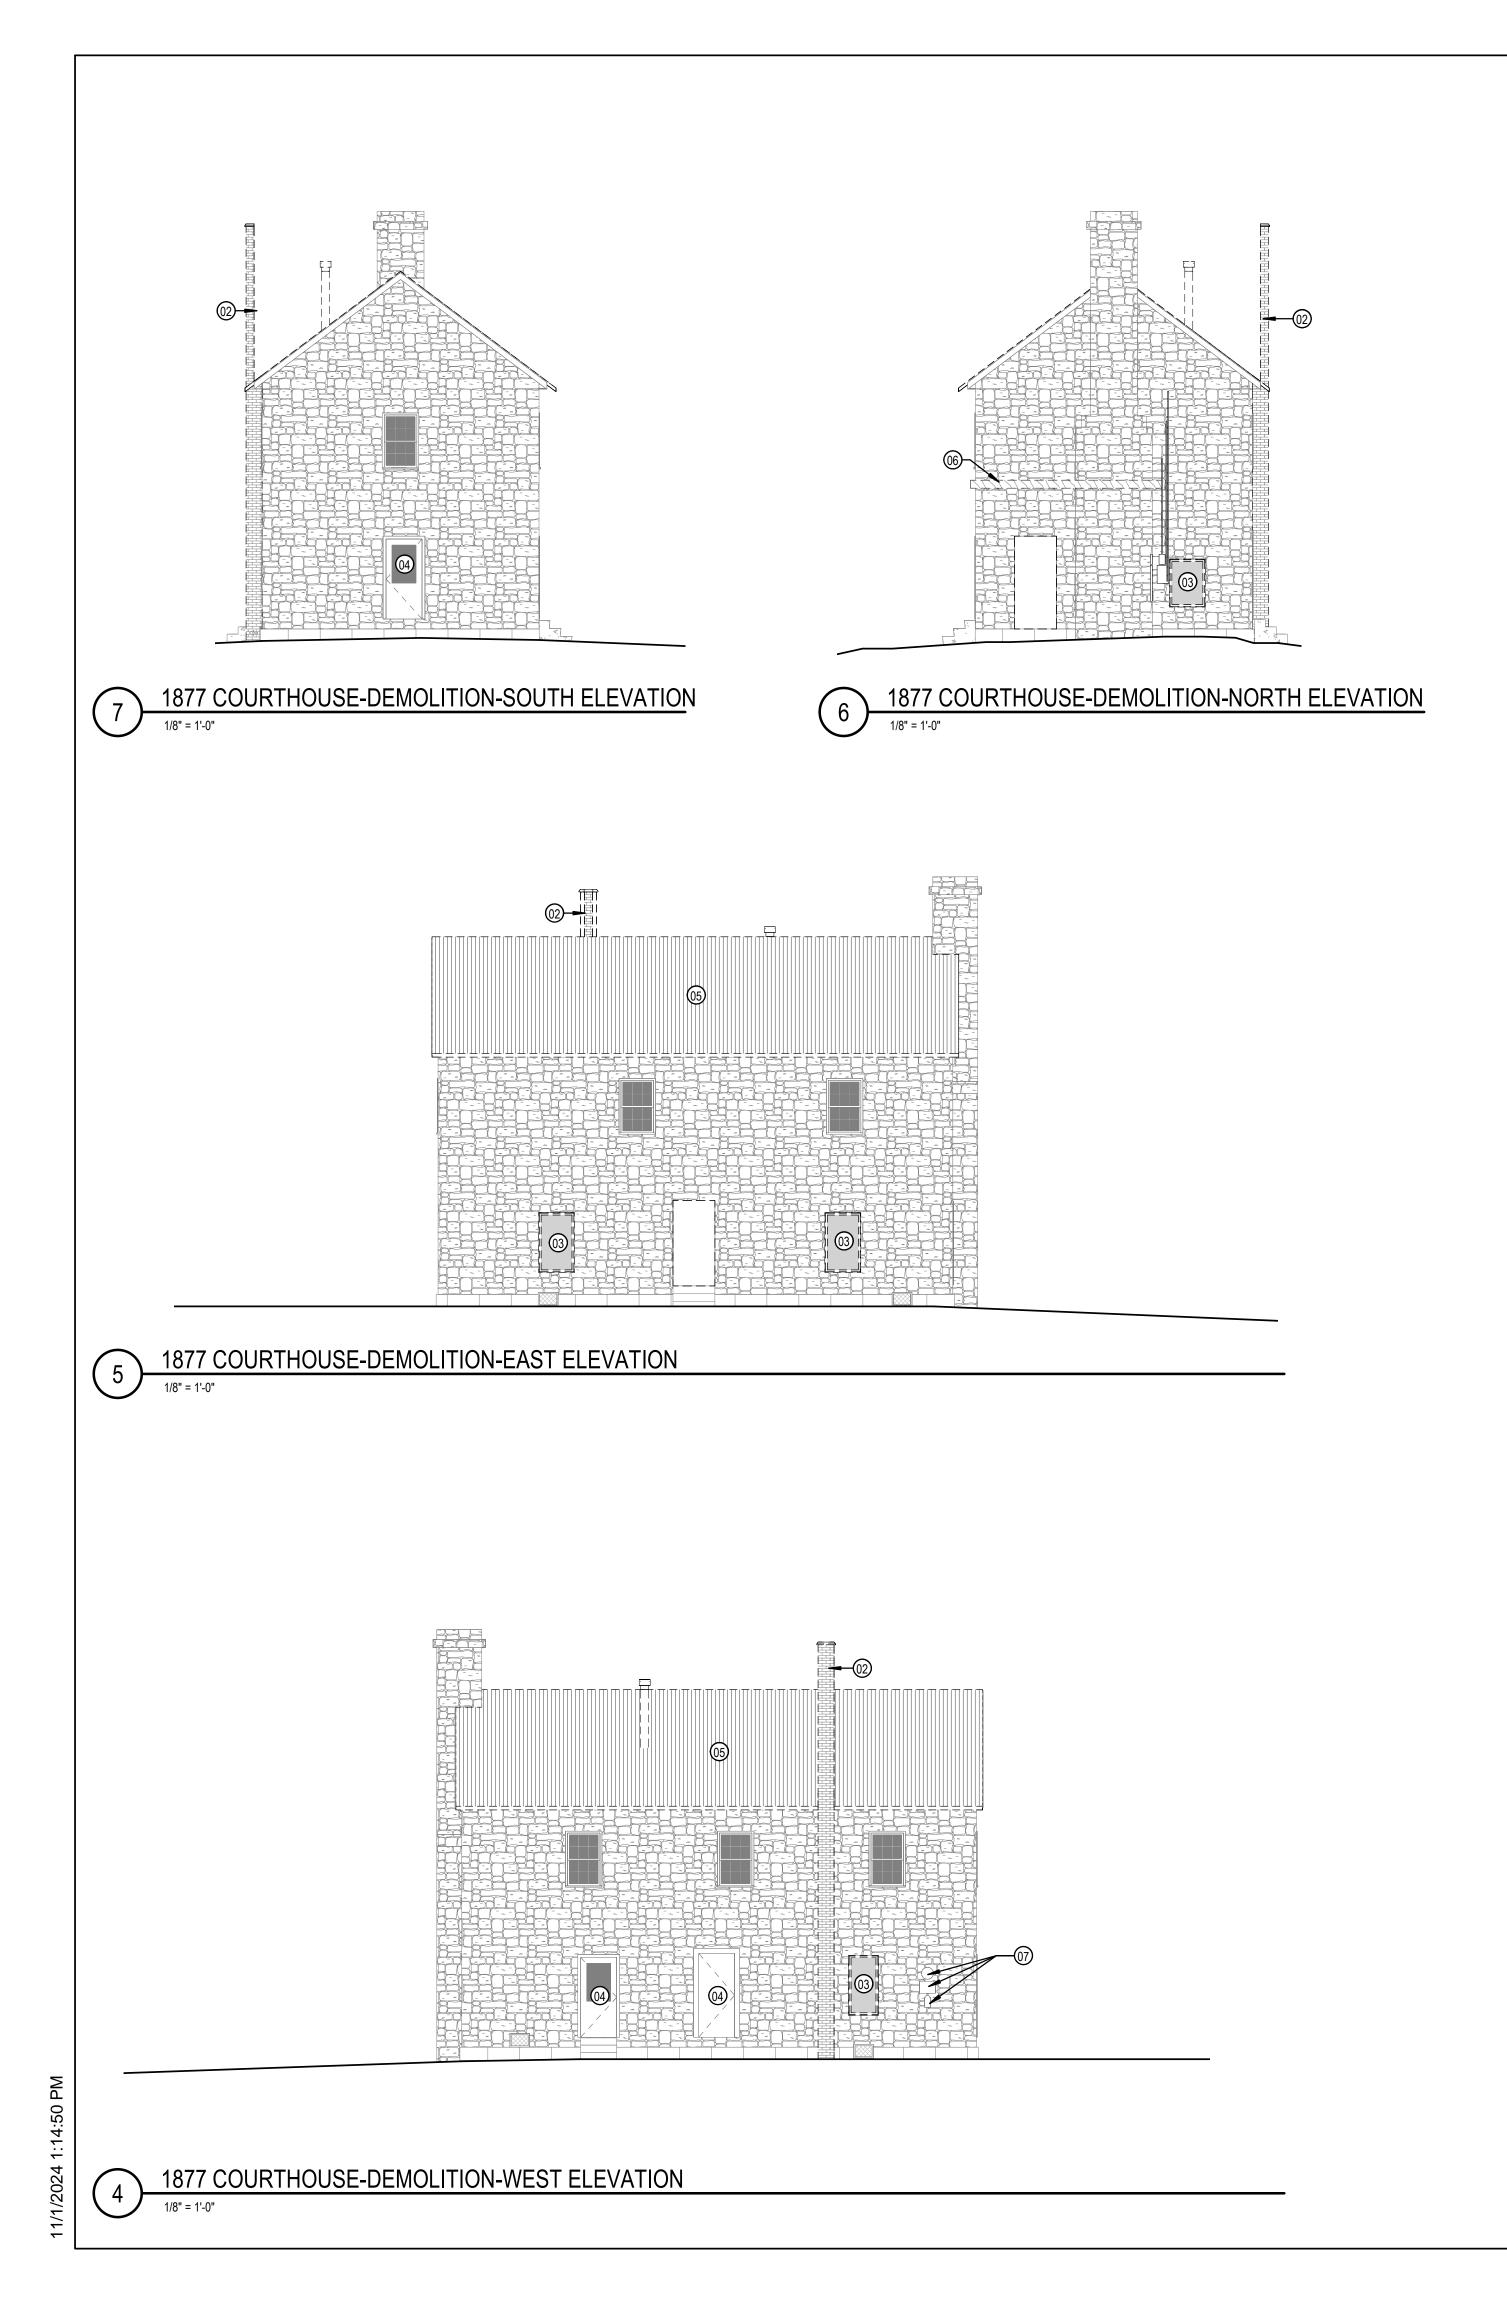

\ 1877 COURTHOUSE-DEMOLITION-FIRST FLOOR

GENERAL NOTES

- IMMEDIATELY ON DISCOVERY OF THE NEED FOR CLARIFICATION
 OF THE CONTRACT DOCUMENTS, SUBMIT A REQUEST FOR
 INFORMATION TO ARCHITECT.
- INFORMATION TO ARCHITECT.

 2. THESE DOCUMENTS SHOULD NO BE CONSIDERED AS A SURVEY OF EXISTING CONDITIONS. THE GENERAL CONTRACTOR SHALL NOTIFY ARCHITECT IMMEDIATELY OF ANY DISCREPANCIES OR
- OMISSIONS BETWEEN DOCUMENTS AND FIELD CONDITIONS
 BEFORE COMMENCING ANY WORK AND REQUEST CLARIFICATION.

 3. ELEMENTS NOTED WITHIN KEYNOTES ARE BASED UPON VISUAL
 OBSERVATIONS AT THE TIME OF SURVEY, CONTRACTOR TO
- VERIFY ANY ADDITIONAL DETERIORATION.

 4. FIELD VERIFY ALL EXISTING DIMENSIONS, ELEVATIONS, & CONDITIONS PRIOR TO COMMENCEMENT OF WORK
- CONDITIONS PRIOR TO COMMENCEMENT OF WORK.

 5. ALL DIMENSIONS ARE TO FACE OF MATERIAL UNLESS NOTED
- ALL DOOR AND WINDOWS THAT ARE TO REMAIN SHALL BE PROTECTED DURING CONSTRUCTION.

 DO NOT DEMONS BOARDS OF OTHER WOODEN TRIM.
- 7. DO NOT REMOVE BASE BOARDS OR OTHER WOODEN TRIM;
 EXCEPT DURING REPOINTING AND REPLASTERING WHERE
 NEEDED, PROTECT DURING CONSTRUCTION.

KEYNOTES

- 01 DEMO WOOD STUD WALL AFTER REHABILITATION WORK HAS BEEN COMPLETED; PREP AREA TO RECEIVE TEMPORARY STAIR RAIL
- O2 CAREFULLY DECONSTRUCT NON-ORIGINAL BRICK MASONRY CHIMNEY. VOID WITHIN WALL THAT RESULTS FROM THE REMOVAL OF THE CHIMNEY, SHALL BE FILLED WITH MATCHING STONE WITH A LIME-BASED MORTAR
- DEMO NON-HISTORIC METAL FRAMED WINDOW. PREP OPEINIG TO RECIEVE REPLICA WOOD WINDOW.
- 04 PROTECT DOOR DURING CONSTRUCTION
- DEMO METAL ROOF, WOOD UNDERLAYMENT AND INSULATION; WOOD RAFTERS IN GOOD CONDITION MAY REMAIN, DETERIORATED RAFTERS MAY REQUIRE REPLACEMENT OR SISTERING. CONTRACTOR TO DETERMINE IN THE FIELD.
- 06 CAREFULLY DEMO REMAINING SHED ROOF AND PREP STONE WALL FOR REPAIR
- 07 CAREFULLY REMOVE HISTORIC PLAQUES AND MARK DOWN EXACT LOCATION FOR RE-PLACEMENT AFTER REHABILITATION WORK IS COMPLETED
- 08 REMOVE ALL VEGETATION WITHIN DESIGNATED AREA AROUND THE BUILDING ENSURE THAT IT WILL NOT REGROW

BANDERA COUNTY VISITOR CENTER

COURTHOUSE

1877

BANDERA COUNTY V
SHEET TITLE:
DEMOLITION PLANS -


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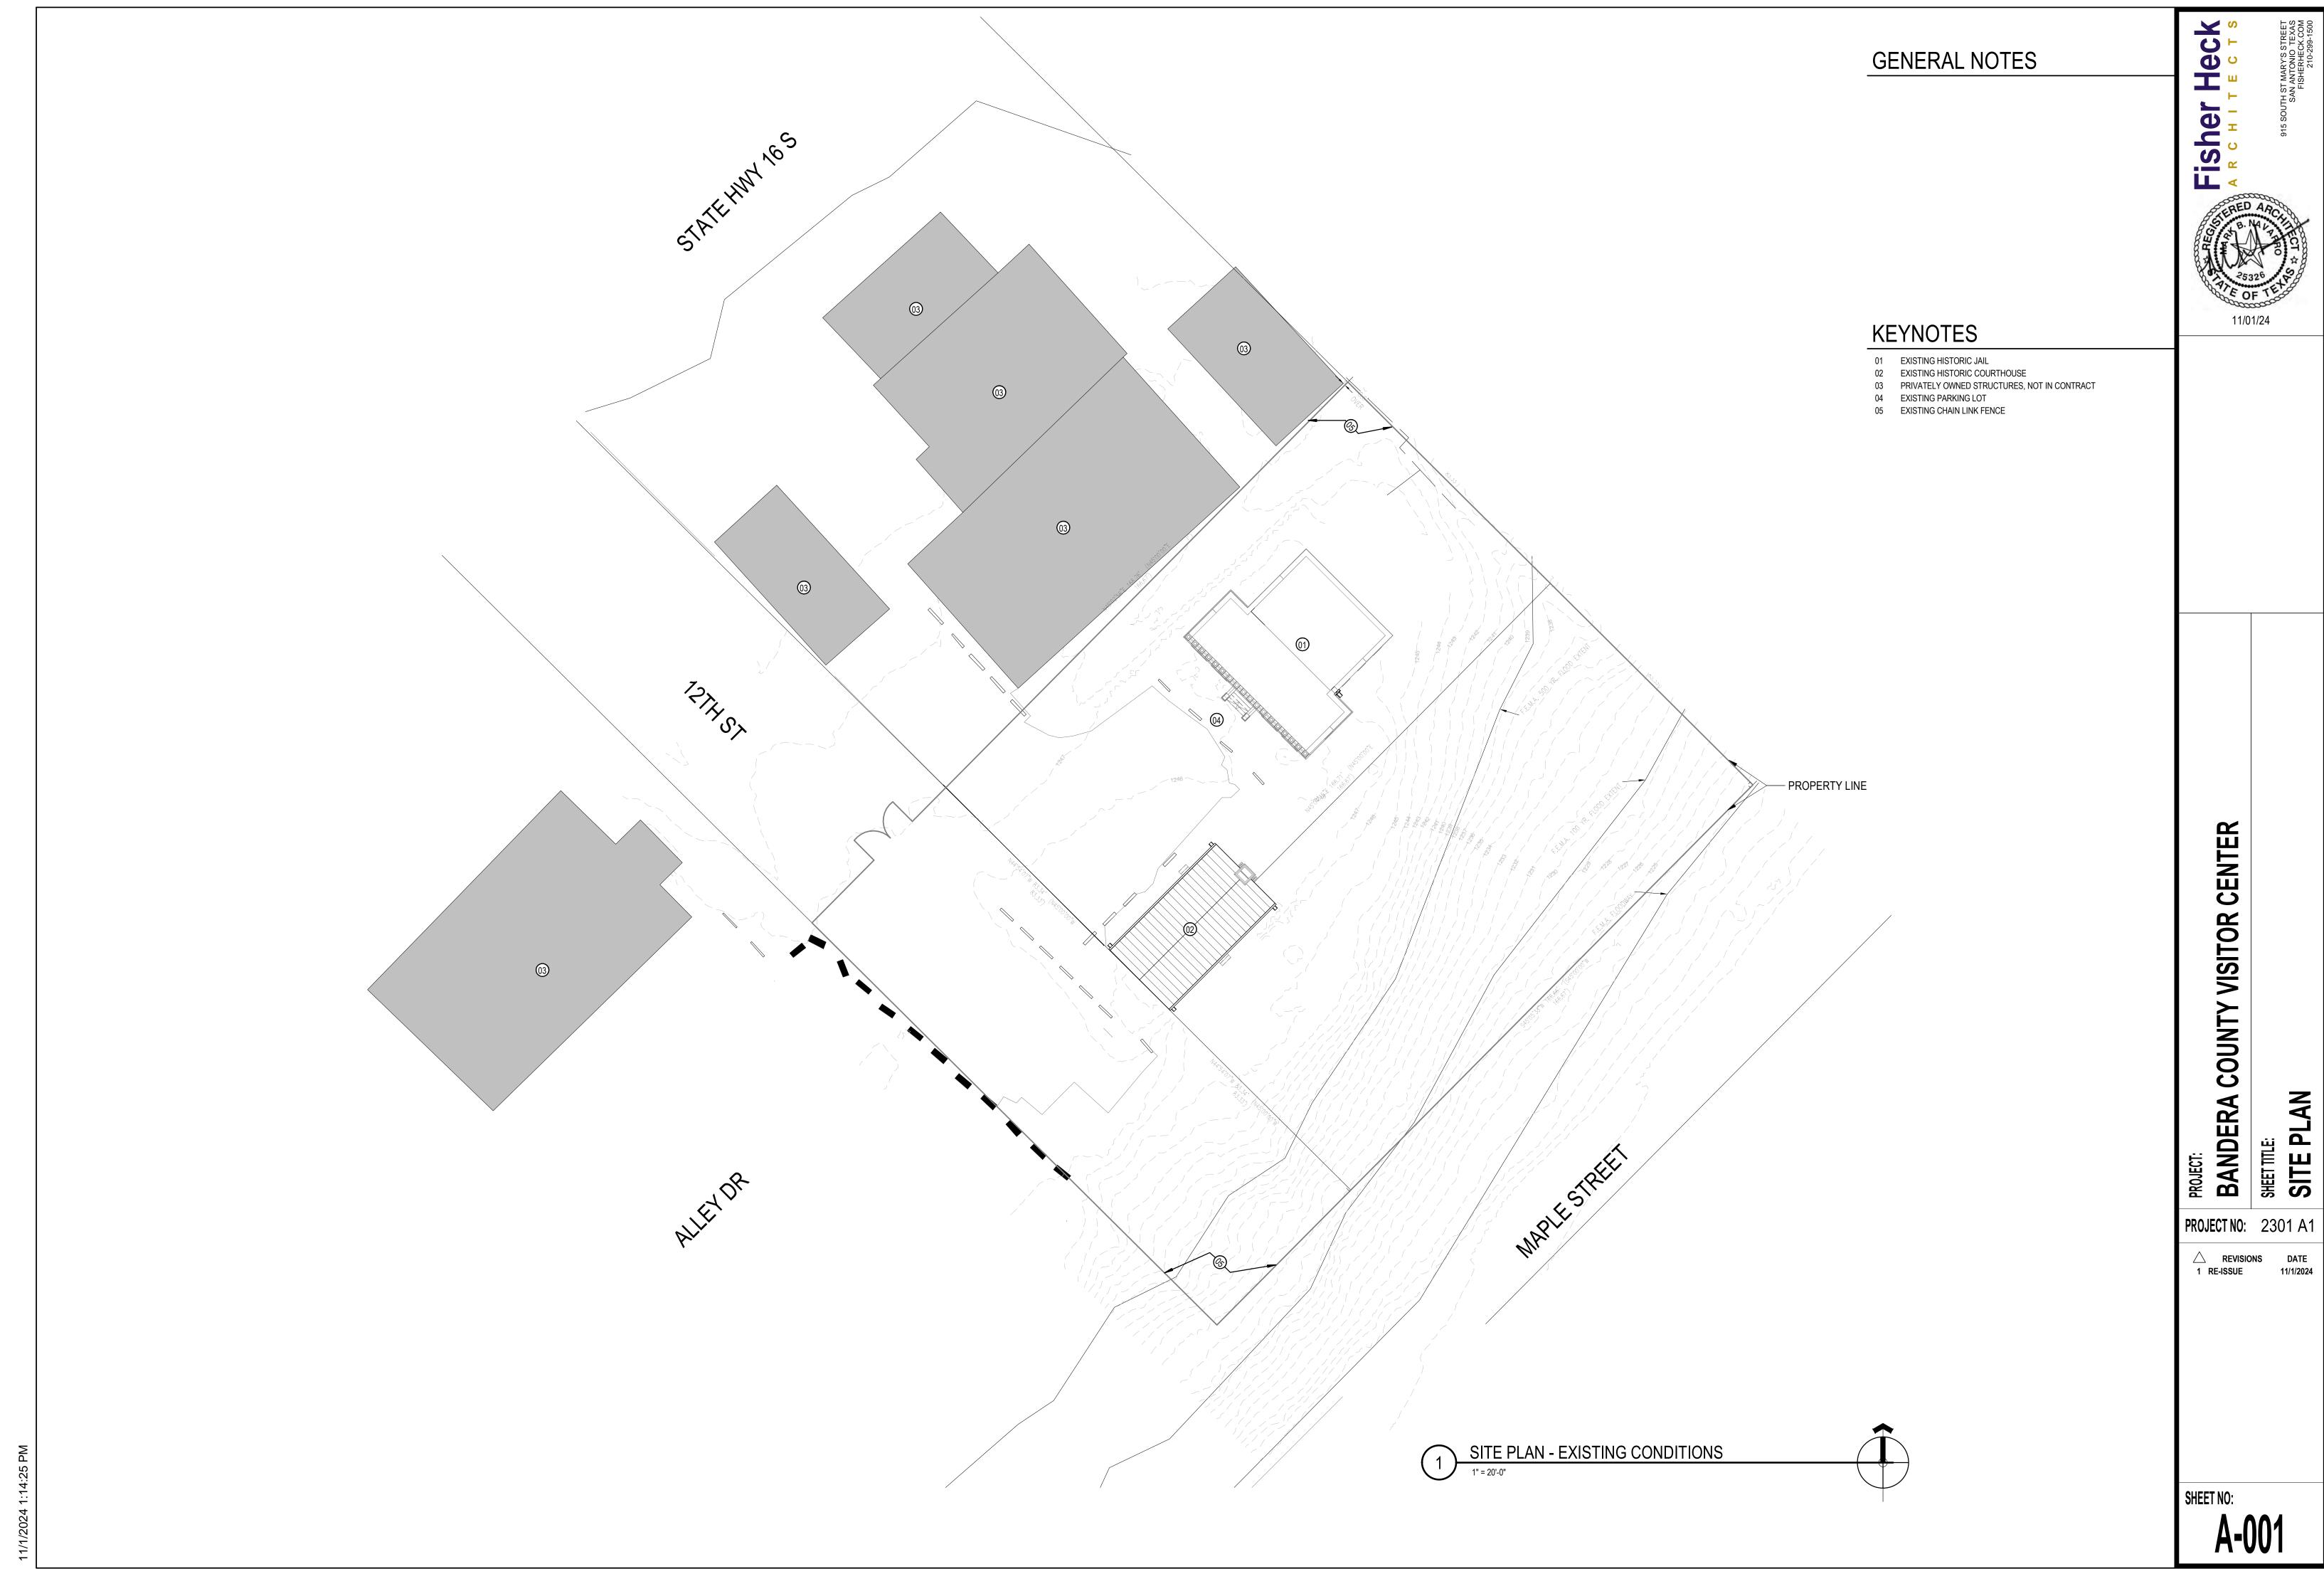
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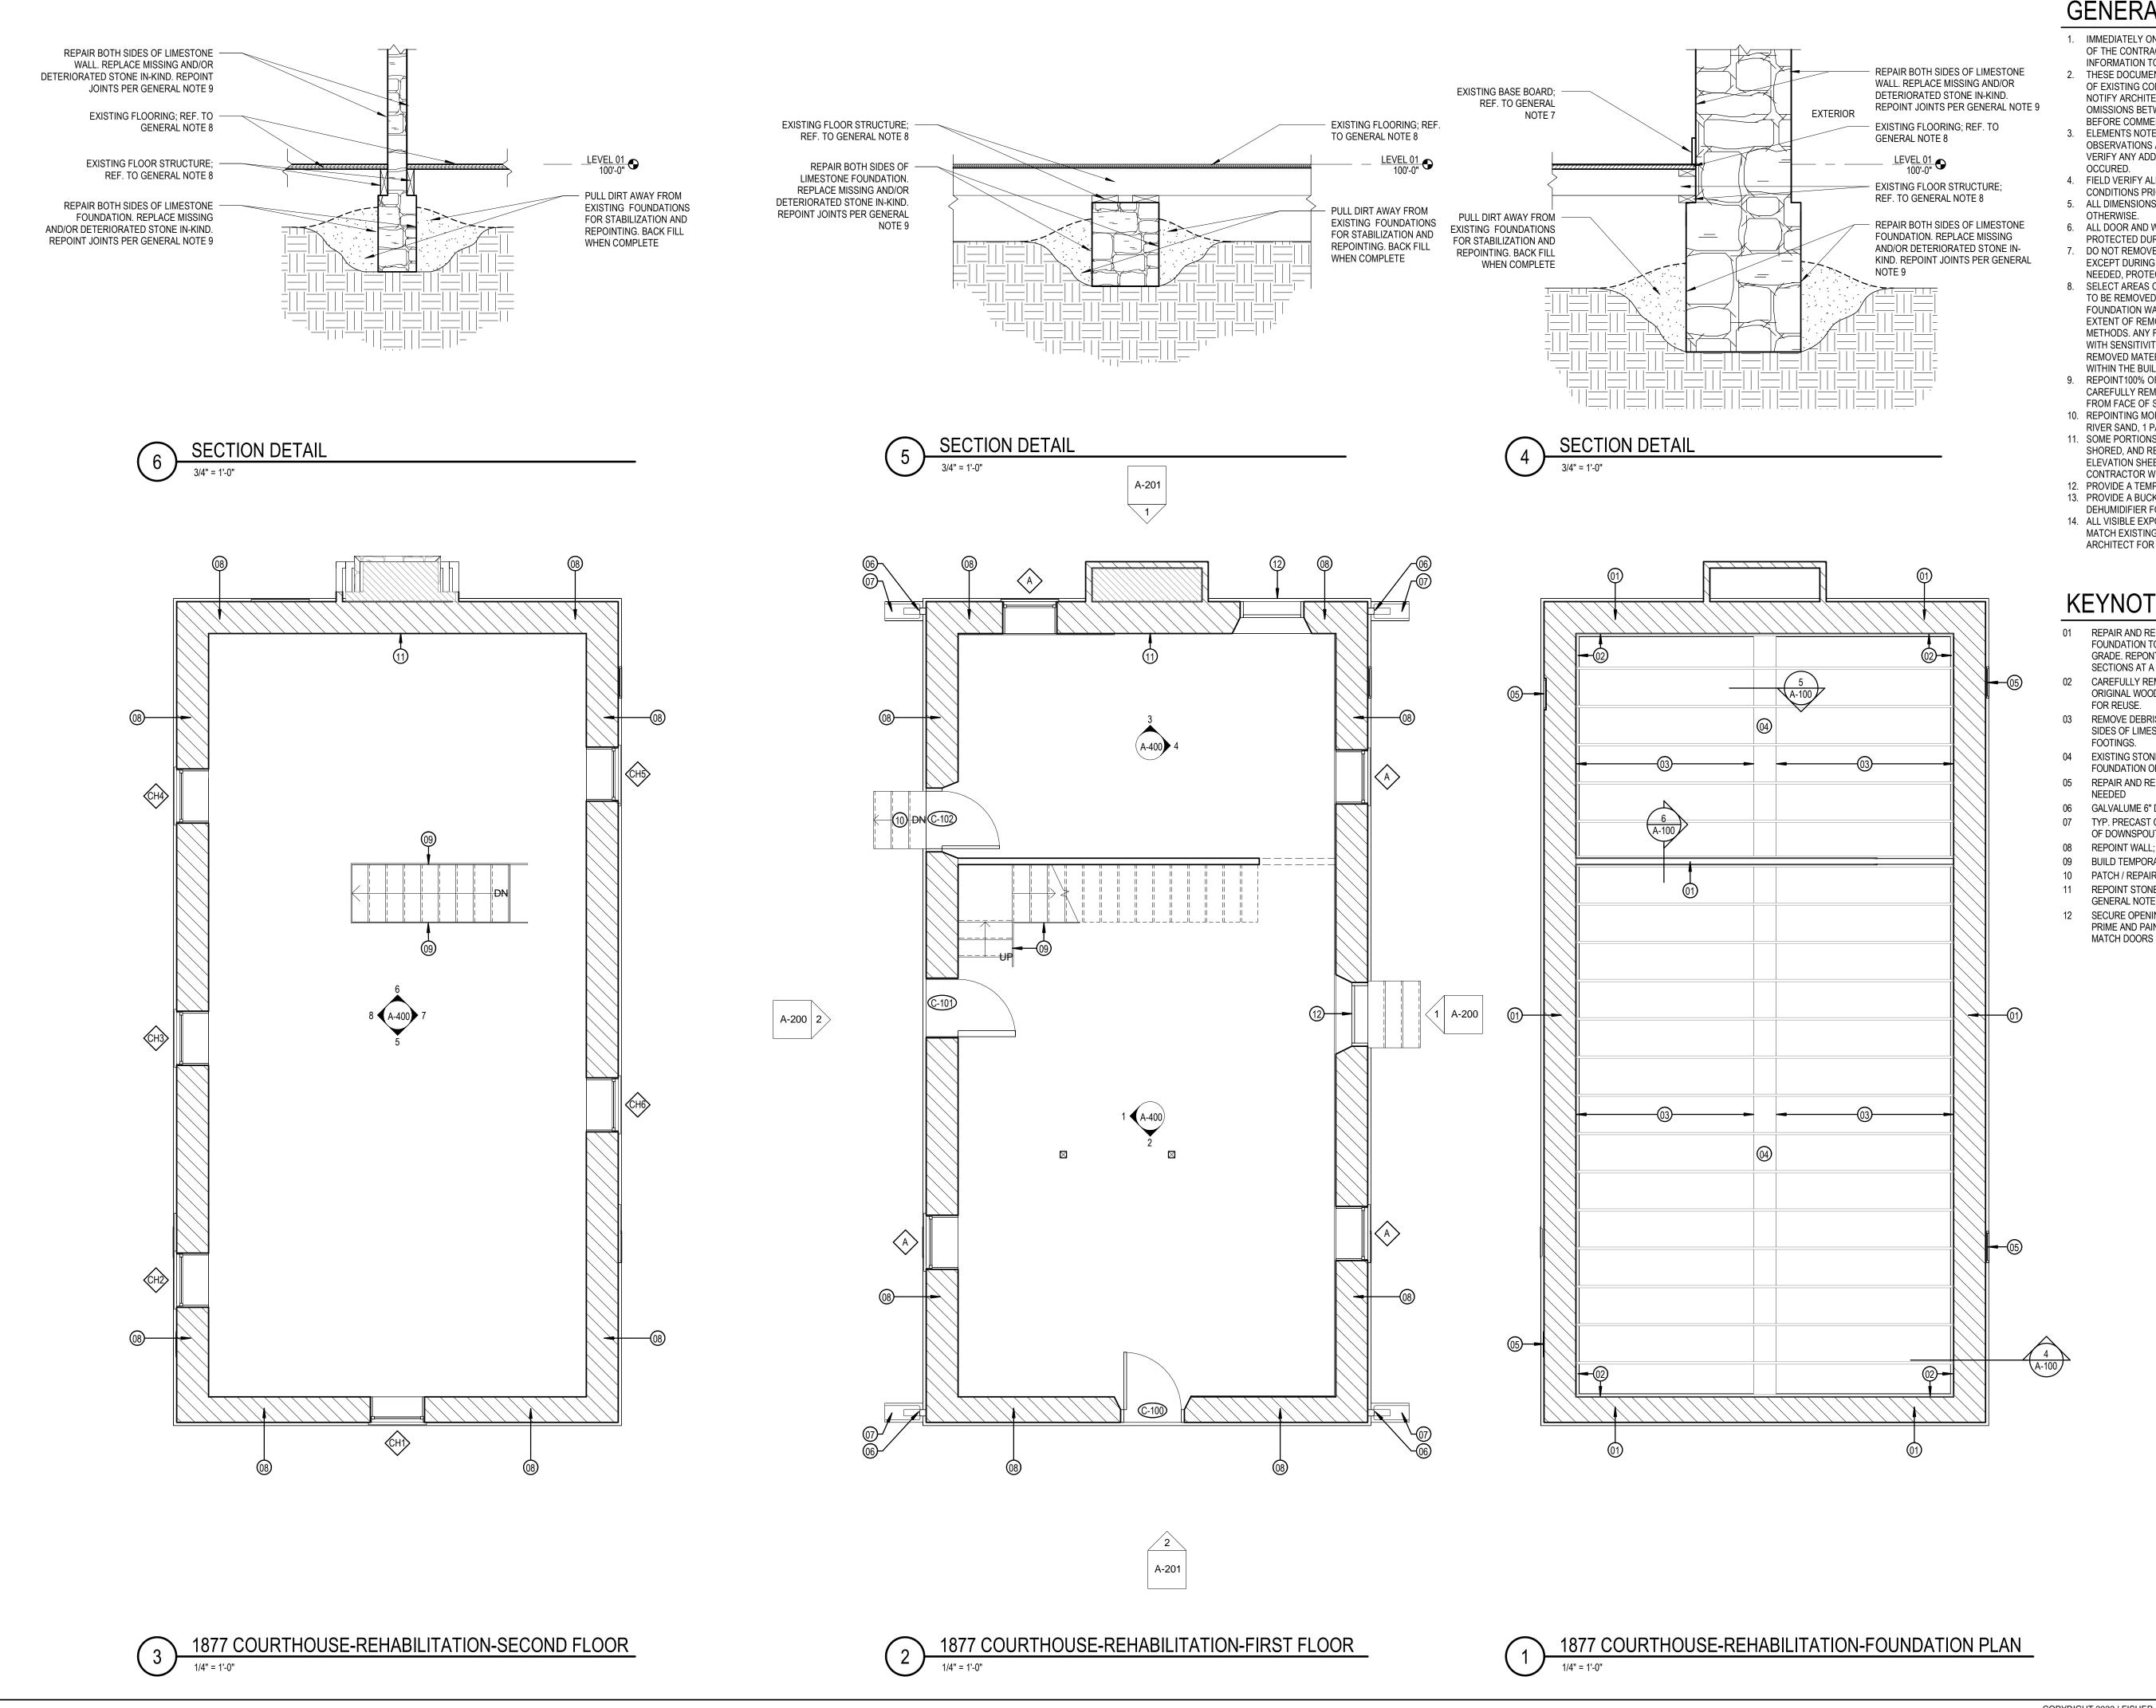
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SHEET TITLE:
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COUNTY VISITOR

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PROJECT NO: 2301 A1

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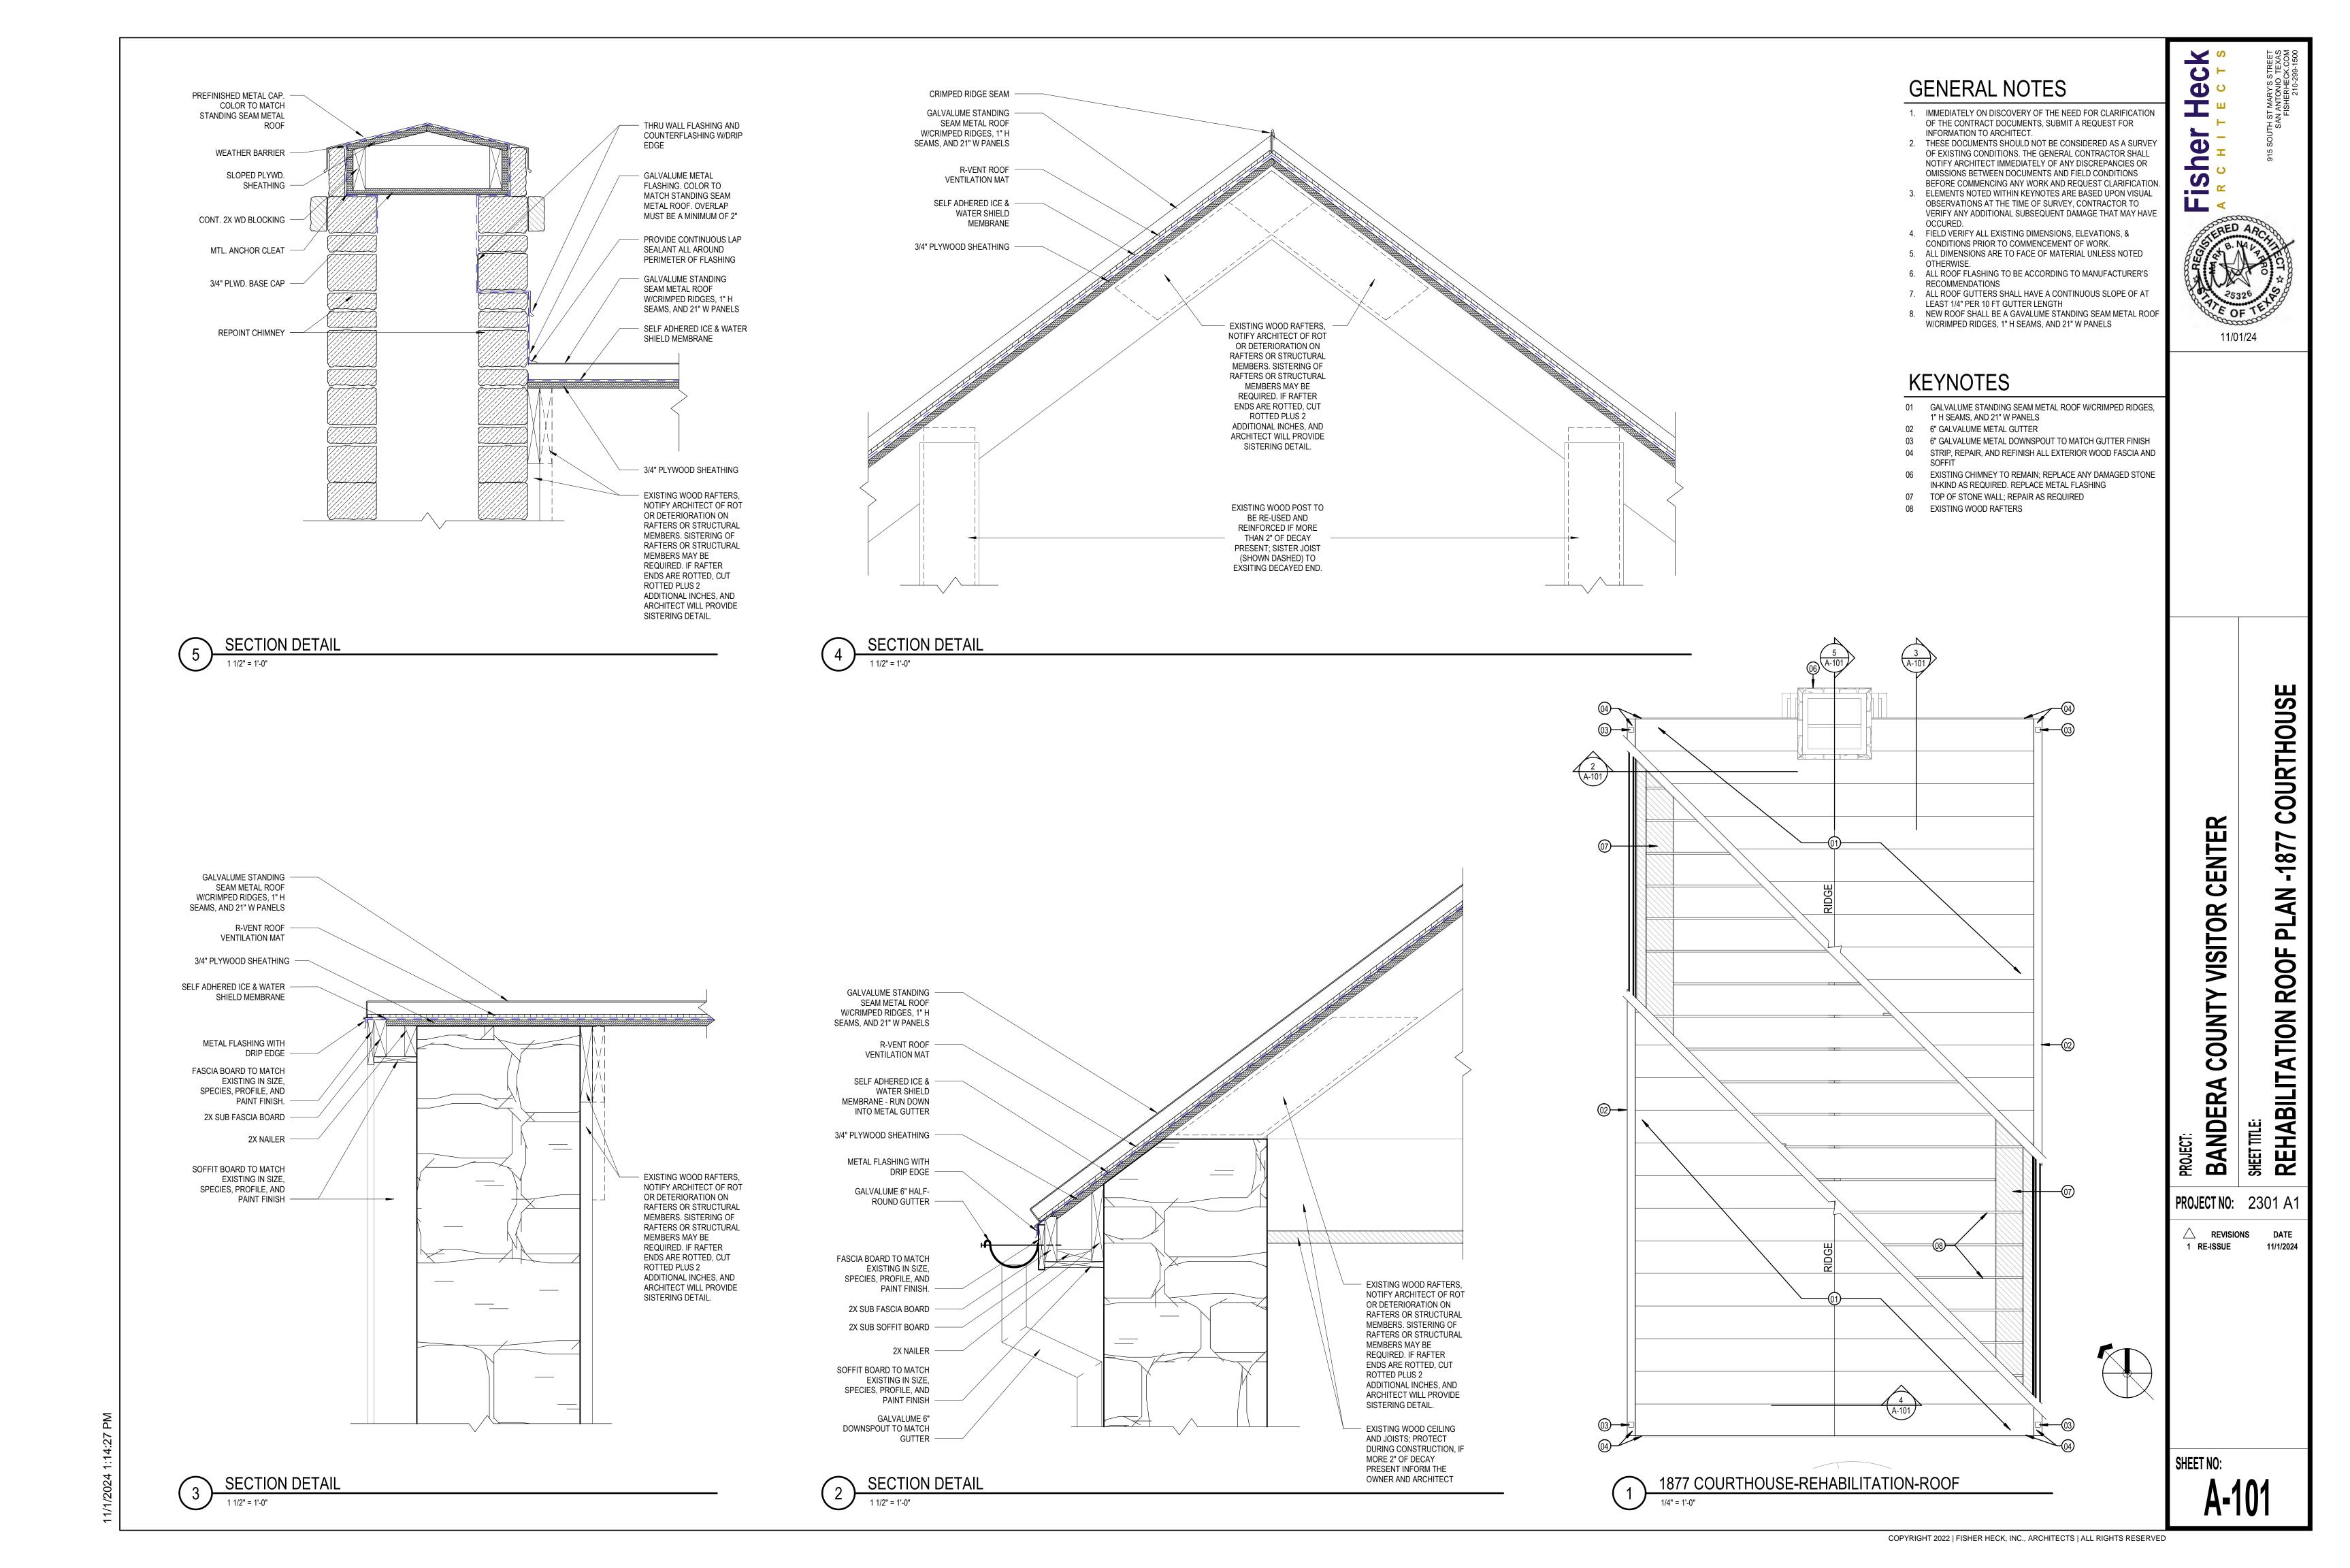
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- 4. FIELD VERIFY ALL EXISTING DIMENSIONS, ELEVATIONS, & CONDITIONS PRIOR TO COMMENCEMENT OF WORK.
- 5. ALL DIMENSIONS ARE TO FACE OF MATERIAL UNLESS NOTED OTHERWISE.
- 6. ALL DOOR AND WINDOWS THAT ARE TO REMAIN SHALL BE PROTECTED DURING CONSTRUCTION.
- 7. DO NOT REMOVE BASE BOARDS OR OTHER WOODEN TRIM; EXCEPT DURING REPOINTING AND REPLASTERING WHERE
- NEEDED, PROTECT DURING CONSTRUCTION. 8. SELECT AREAS OF FLOORING AND FLOOR STRUCTURE MAY NEED TO BE REMOVED DURING REPOINTING AND STABILIZATION OF FOUNDATION WALLS. CONTRACTOR WILL DETERMINE THE EXTENT OF REMOVALS NECESSARY UNDER MEANS AND METHODS. ANY FLOOR STRUCTURE REMOVED WILL BE DONE WITH SENSITIVITY SO IT HAS THE POTENTIAL FOR REUSE. REMOVED MATERIALS WILL BE LABELED AND CAREFULLY STORED WITHIN THE BUILDING
- 9. REPOINT100% OF EXTERIOR AND INTERIOR STONE WALLS. CAREFULLY REMOVE EXISTING MORTAR A MINIMUM OF 2 INCHES FROM FACE OF STONE.
- 10. REPOINTING MORTAR TO CONSIST OF 4 PARTS BUFF COLORED RIVER SAND, 1 PART LIME, 1/4 PART PORTLAND CEMENT.
- 11. SOME PORTIONS OF WALL MAY NEED TO BE DISASEMBLED, SHORED, AND REASSEMBLED USING SAME OR LIKE STONE. ELEVATION SHEETS INDICATE SOME OF THESE AREAS. CONTRACTOR WILL DETERMINE IF ADDITIONAL ARE NEEDED.
- 12. PROVIDE A TEMPORARY POWER IN EACH BUILDING. 13. PROVIDE A BUCKETLESS PORTABLE COMMERCIAL GRADE
- DEHUMIDIFIER FOR EACH BUILDING. 14. ALL VISIBLE EXPOSED WOOD SURFACES MUST BE PAINTED TO MATCH EXISTING SURFACE COLOR; PROVIDE SAMPLES TO ARCHITECT FOR APPROVAL, REFER TO SPECS FOR MORE INFO.


KEYNOTES

- 01 REPAIR AND REPOINT BOTH SIDES OF EXISTING LIMESTONE FOUNDATION TO BOTTOM OF FOUNDATION OR 3'-0" MAX. BELOW GRADE. REPONTING SHOULD BE DONE IN NO MORE OF 5'-0"
- ORIGINAL WOOD THAT REMAINS IN GOOD CONDITION AND STORE
- 03 REMOVE DEBRIS FROM CRAWL SPACE. REMOVE SOIL TO EXPOSE SIDES OF LIMESTONE FOOTINGS, AND REPOINT FACES OF
- 04 EXISTING STONE FOOTING; REPAIR AND REPOINT TO BOTTOM OF FOUNDATION OF 4'-0" MAX.
- 05 REPAIR AND REFINISH METAL GRILLE; REPLACE IN-KIND WHERE
- NEEDED
- 07 TYP. PRECAST CONCRETE SPLASH BLOCK 24"Lx10"Wx3"H AT BASE OF DOWNSPOUT
- 09 BUILD TEMPORARY RAIL UP TO SECOND FLOOR
- PATCH / REPAIR CONCRETE STAIR AS NEEDED
- GENERAL NOTES 9,10,11

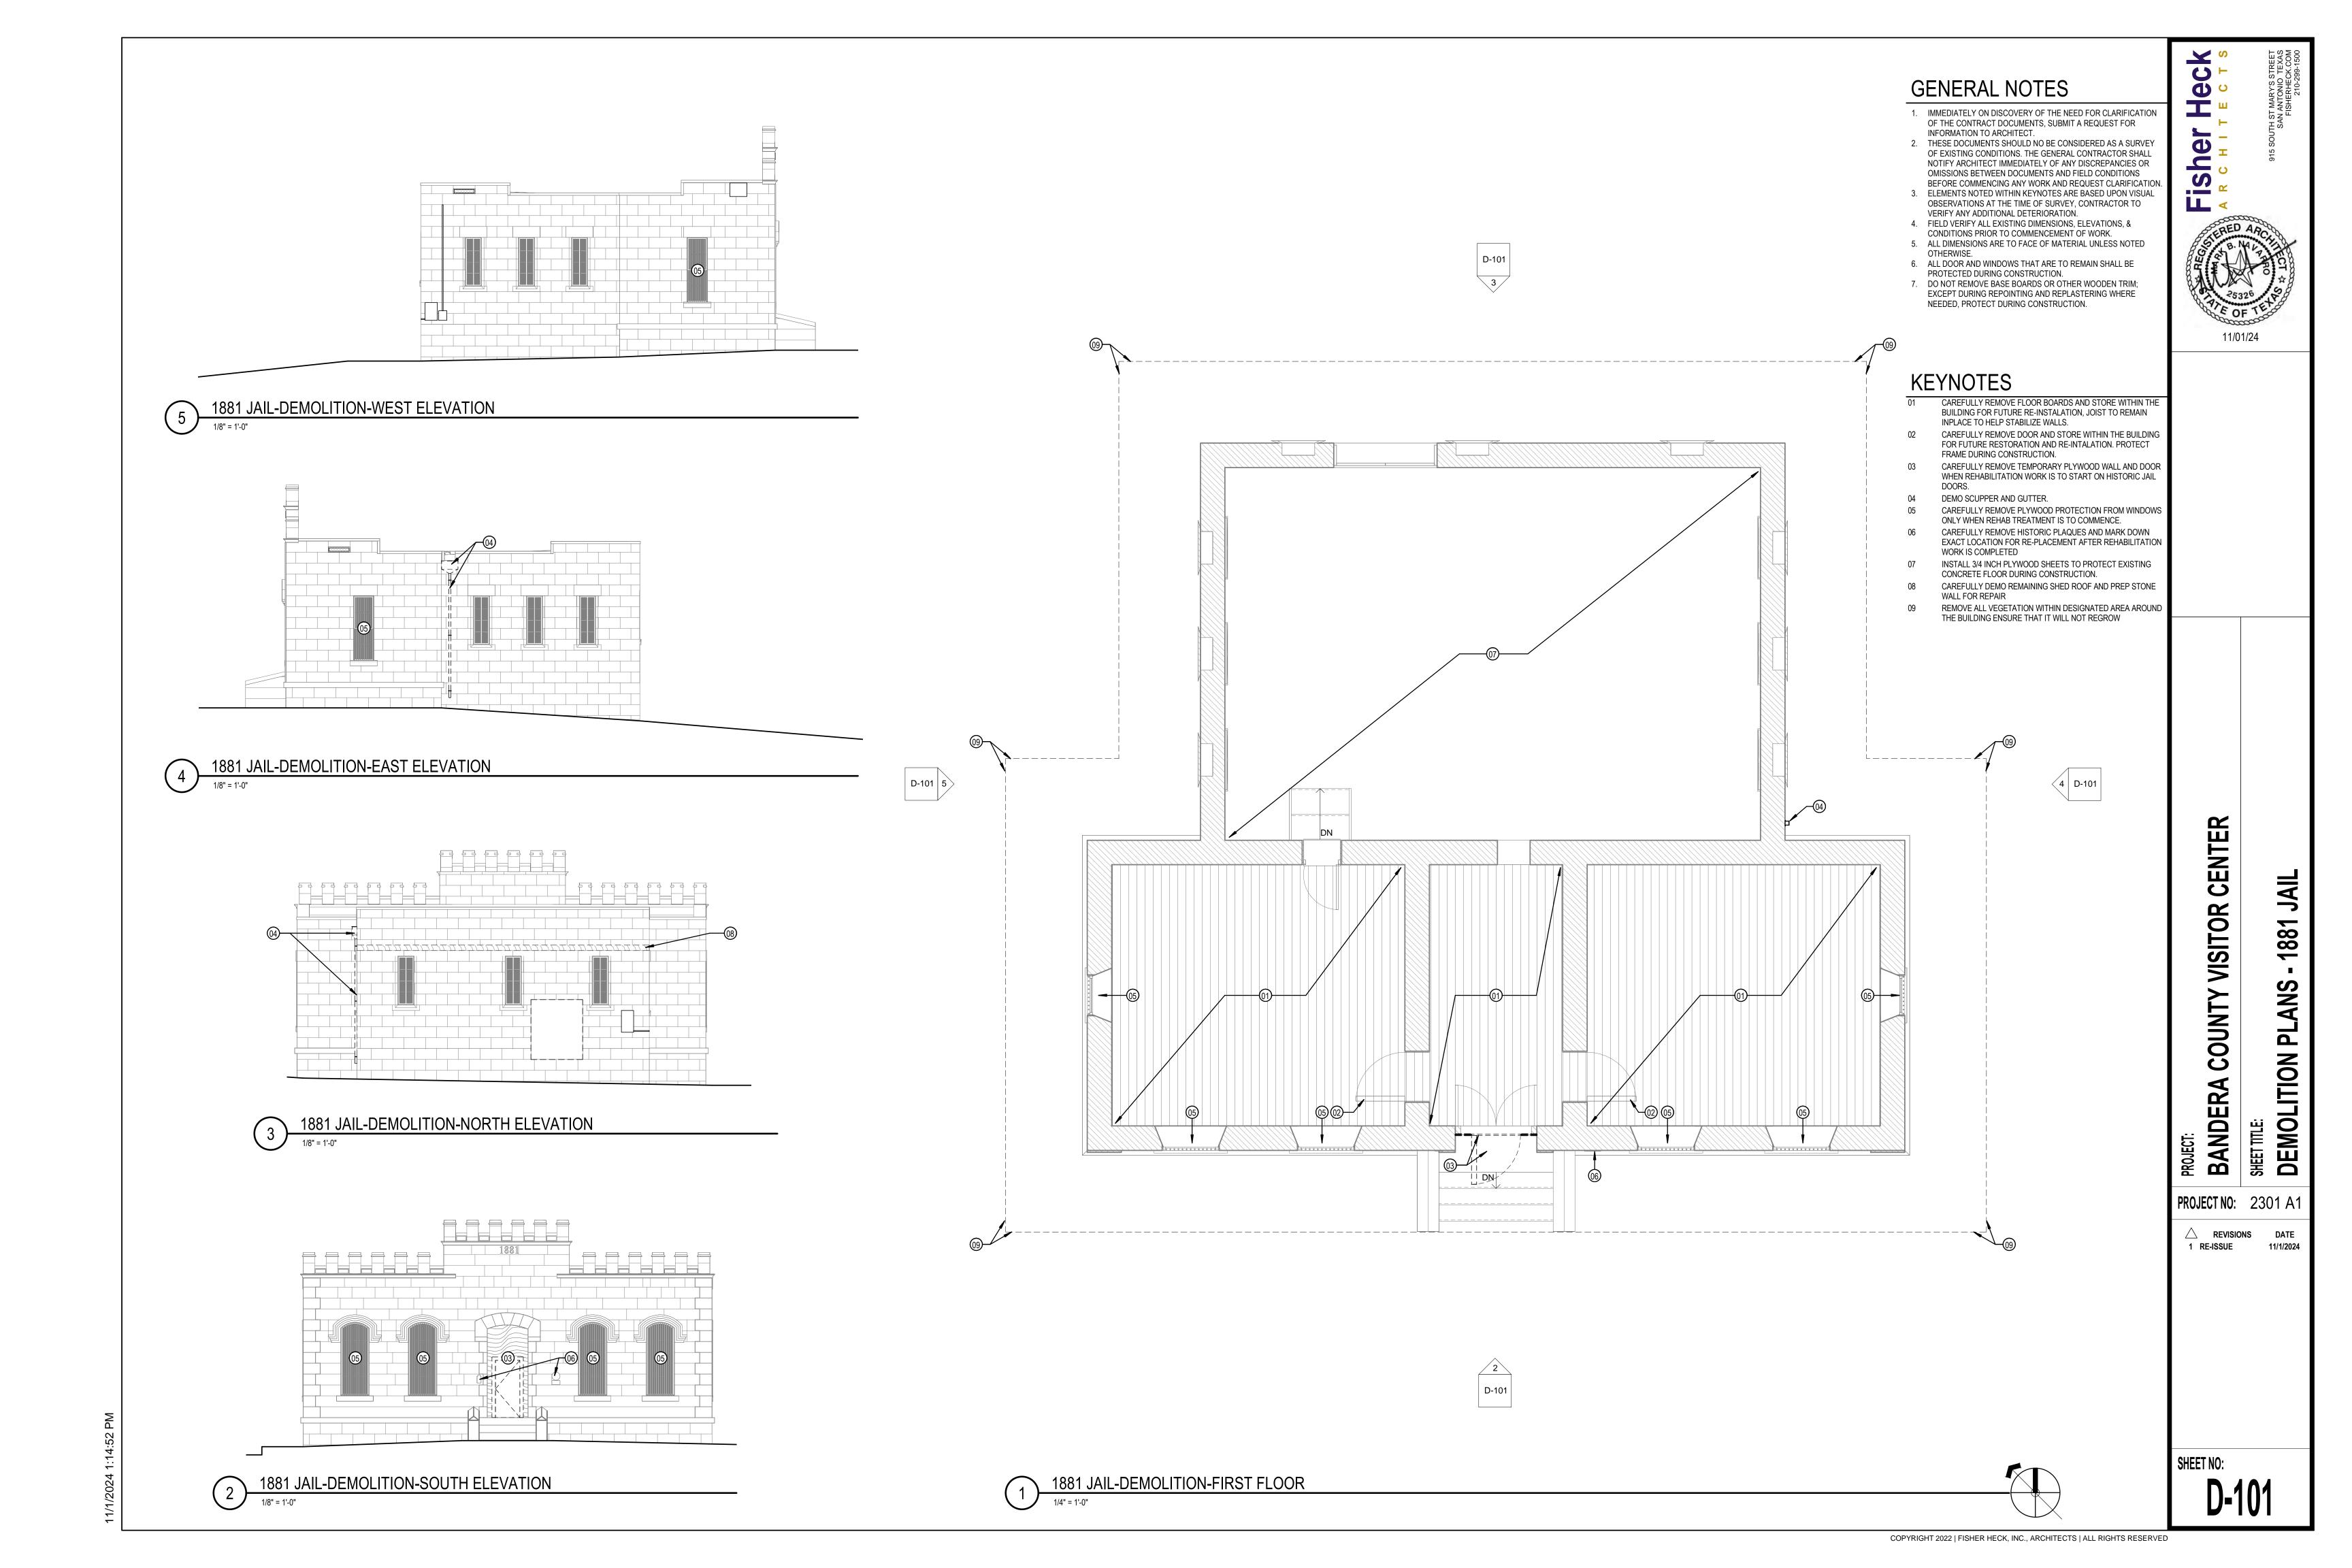- SECTIONS AT A TIME. CAREFULLY REMOVE ALL WOOD FRAMING; SALVAGE ALL

- 06 GALVALUME 6" DOWNSPOUT TO MATCH GUTTER
- 08 REPOINT WALL; REFER TO GENERAL NOTES 9,10,11
- REPOINT STONE CHIMNEY'S FIRE BOX AND HEARTH; REFER TO
- SECURE OPENING WITH 3/4" PRESSURE TREATED PLYWOOD PRIME AND PAINT EXTERIOR FACE WITH SEMI GLOSS PAINT TO



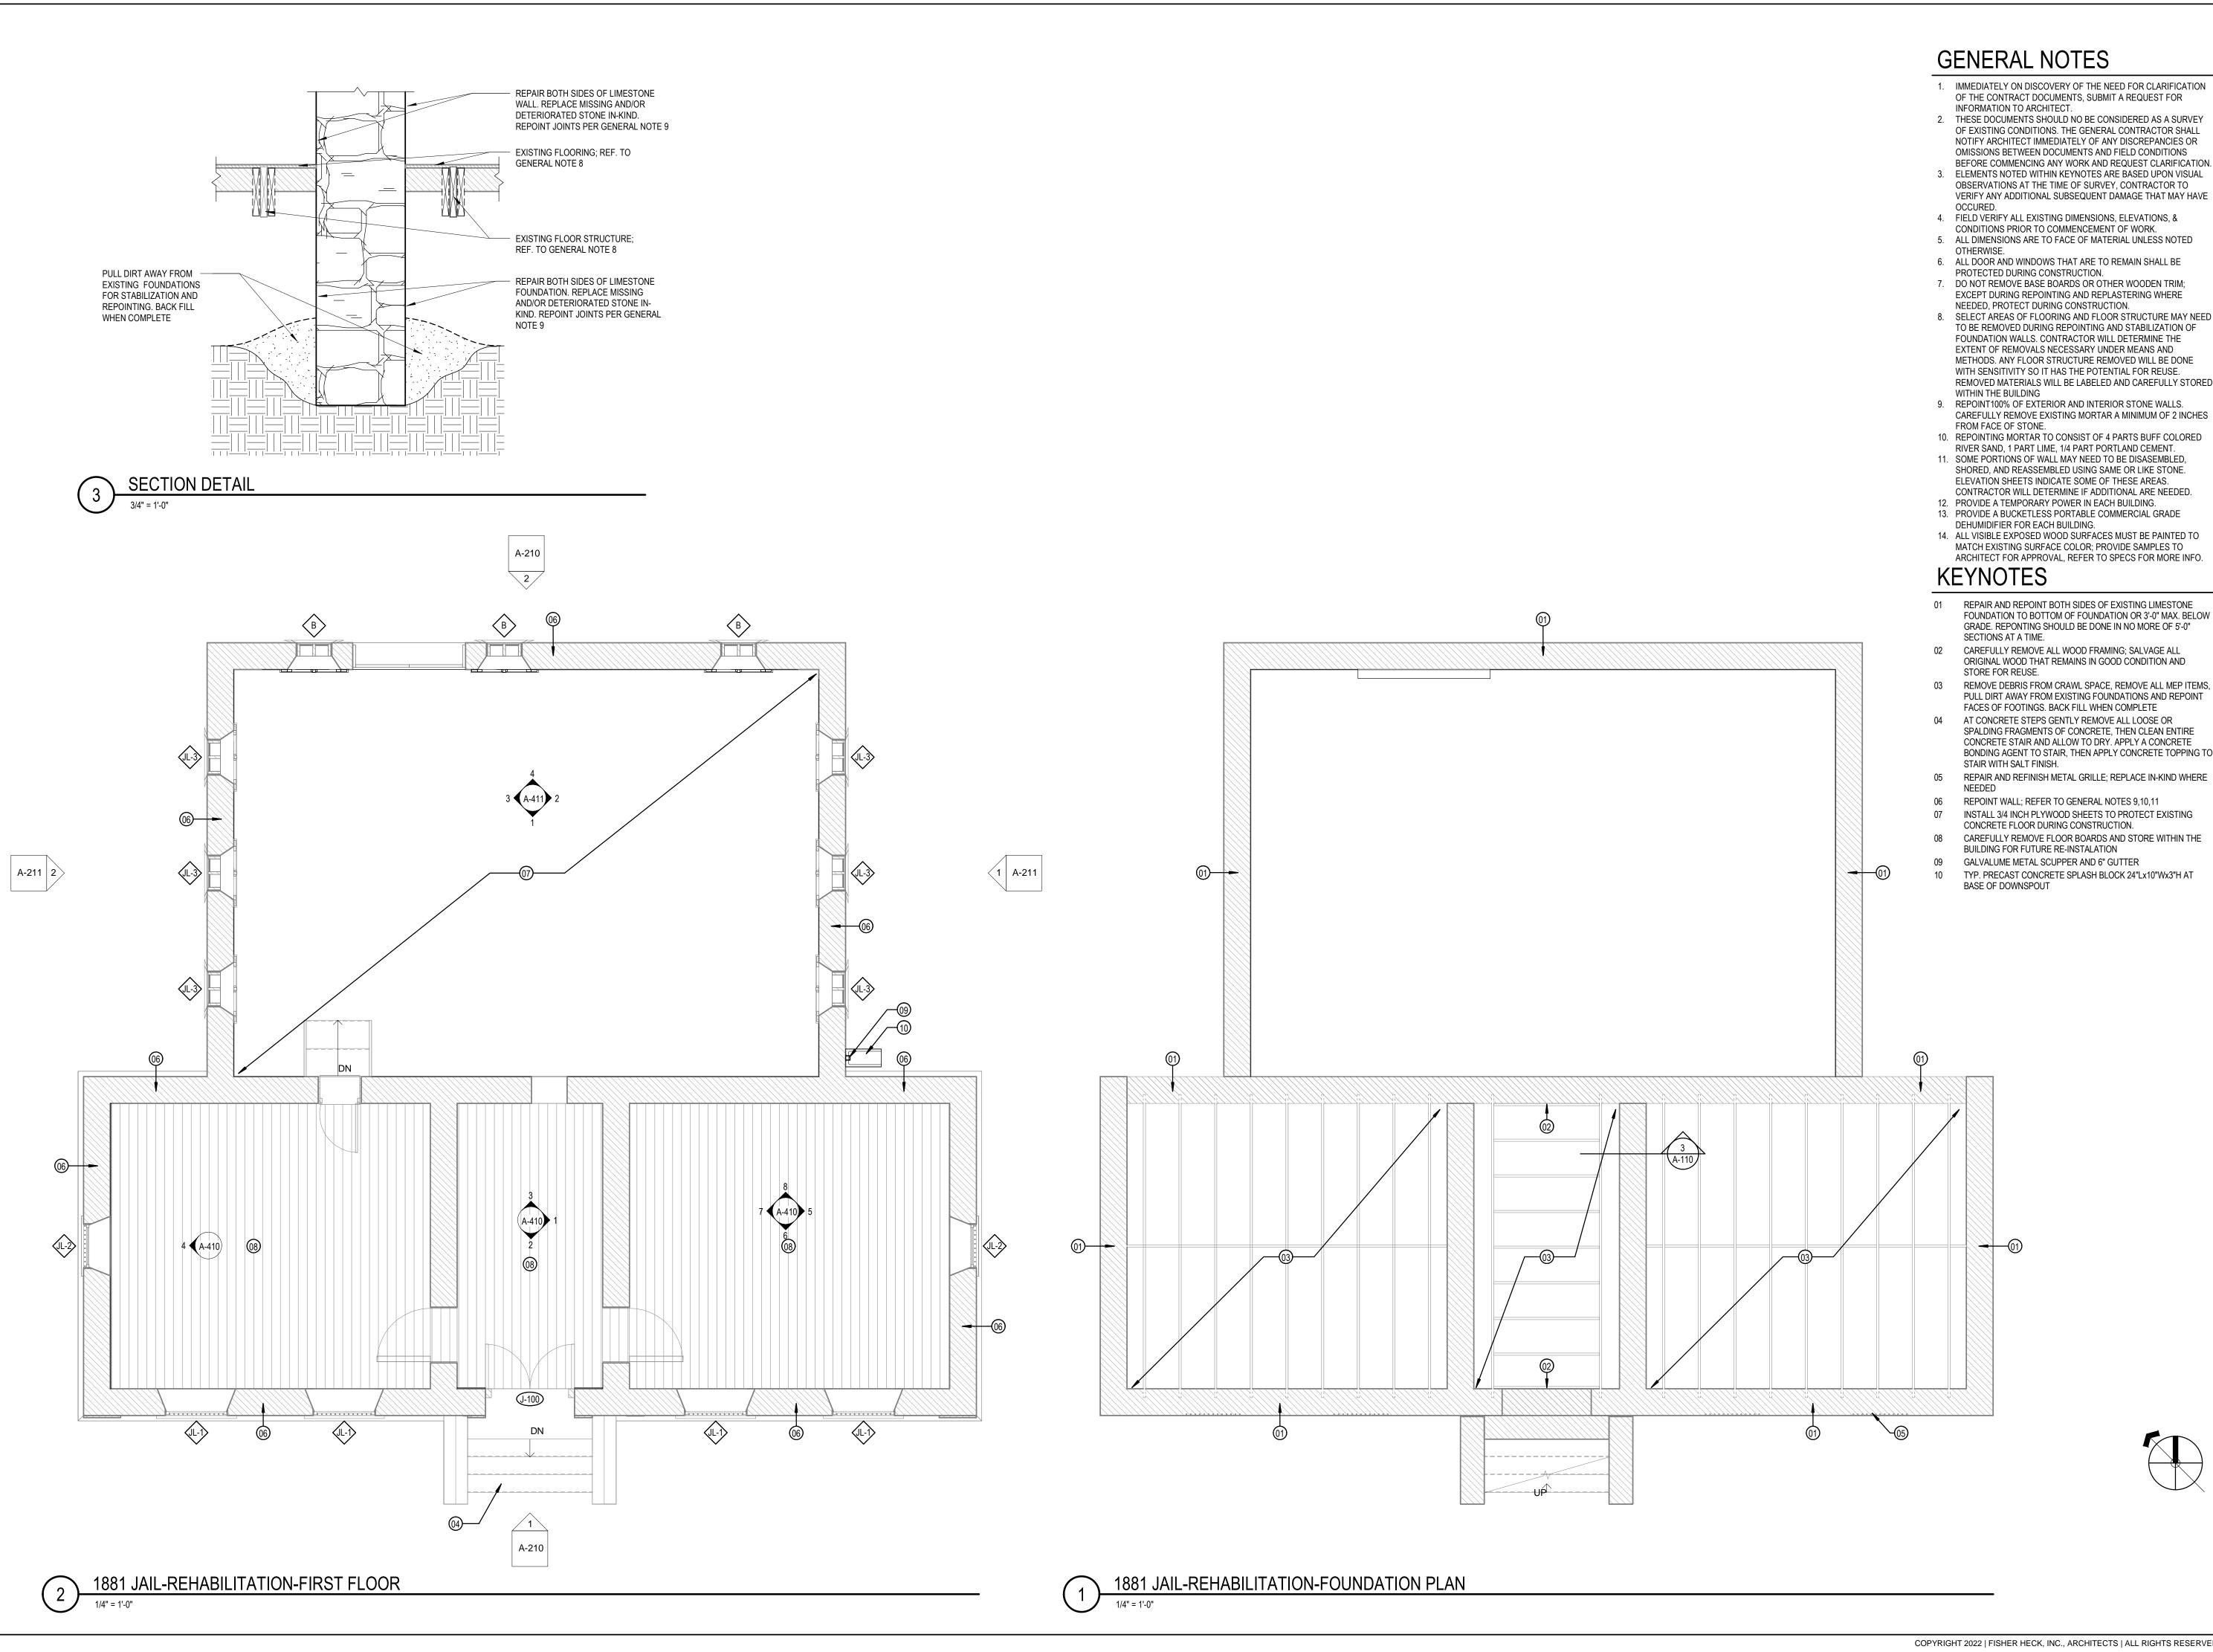

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14. ALL VISIBLE EXPOSED WOOD SURFACES MUST BE PAINTED TO MATCH EXISTING SURFACE COLOR; PROVIDE SAMPLES TO

REPAIR AND REPOINT BOTH SIDES OF EXISTING LIMESTONE FOUNDATION TO BOTTOM OF FOUNDATION OR 3'-0" MAX. BELOW GRADE. REPONTING SHOULD BE DONE IN NO MORE OF 5'-0"

ORIGINAL WOOD THAT REMAINS IN GOOD CONDITION AND

03 REMOVE DEBRIS FROM CRAWL SPACE, REMOVE ALL MEP ITEMS, PULL DIRT AWAY FROM EXISTING FOUNDATIONS AND REPOINT

04 AT CONCRETE STEPS GENTLY REMOVE ALL LOOSE OR SPALDING FRAGMENTS OF CONCRETE, THEN CLEAN ENTIRE CONCRETE STAIR AND ALLOW TO DRY. APPLY A CONCRETE BONDING AGENT TO STAIR, THEN APPLY CONCRETE TOPPING TO

05 REPAIR AND REFINISH METAL GRILLE; REPLACE IN-KIND WHERE

06 REPOINT WALL; REFER TO GENERAL NOTES 9,10,11

08 CAREFULLY REMOVE FLOOR BOARDS AND STORE WITHIN THE

BUILDING FOR FUTURE RE-INSTALATION

GALVALUME METAL SCUPPER AND 6" GUTTER


TYP. PRECAST CONCRETE SPLASH BLOCK 24"Lx10"Wx3"H AT BASE OF DOWNSPOUT

BANDERA COUNTY VISITOR CENTER SHET TITLE:
REHABILITATION F

1881

PROJECT NO: 2301 A1


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CAREFULLY DECONSTRUCT
NON-ORIGINAL BRICK MASONRY
CHIMNEY. VOID WITHIN WALL
RESULTING FROM THE
REMOVAL OF CHIMNEY, SHALL
BE FILLED WITH MATCHING
STONE WITH A LIME BASED
MOTAR

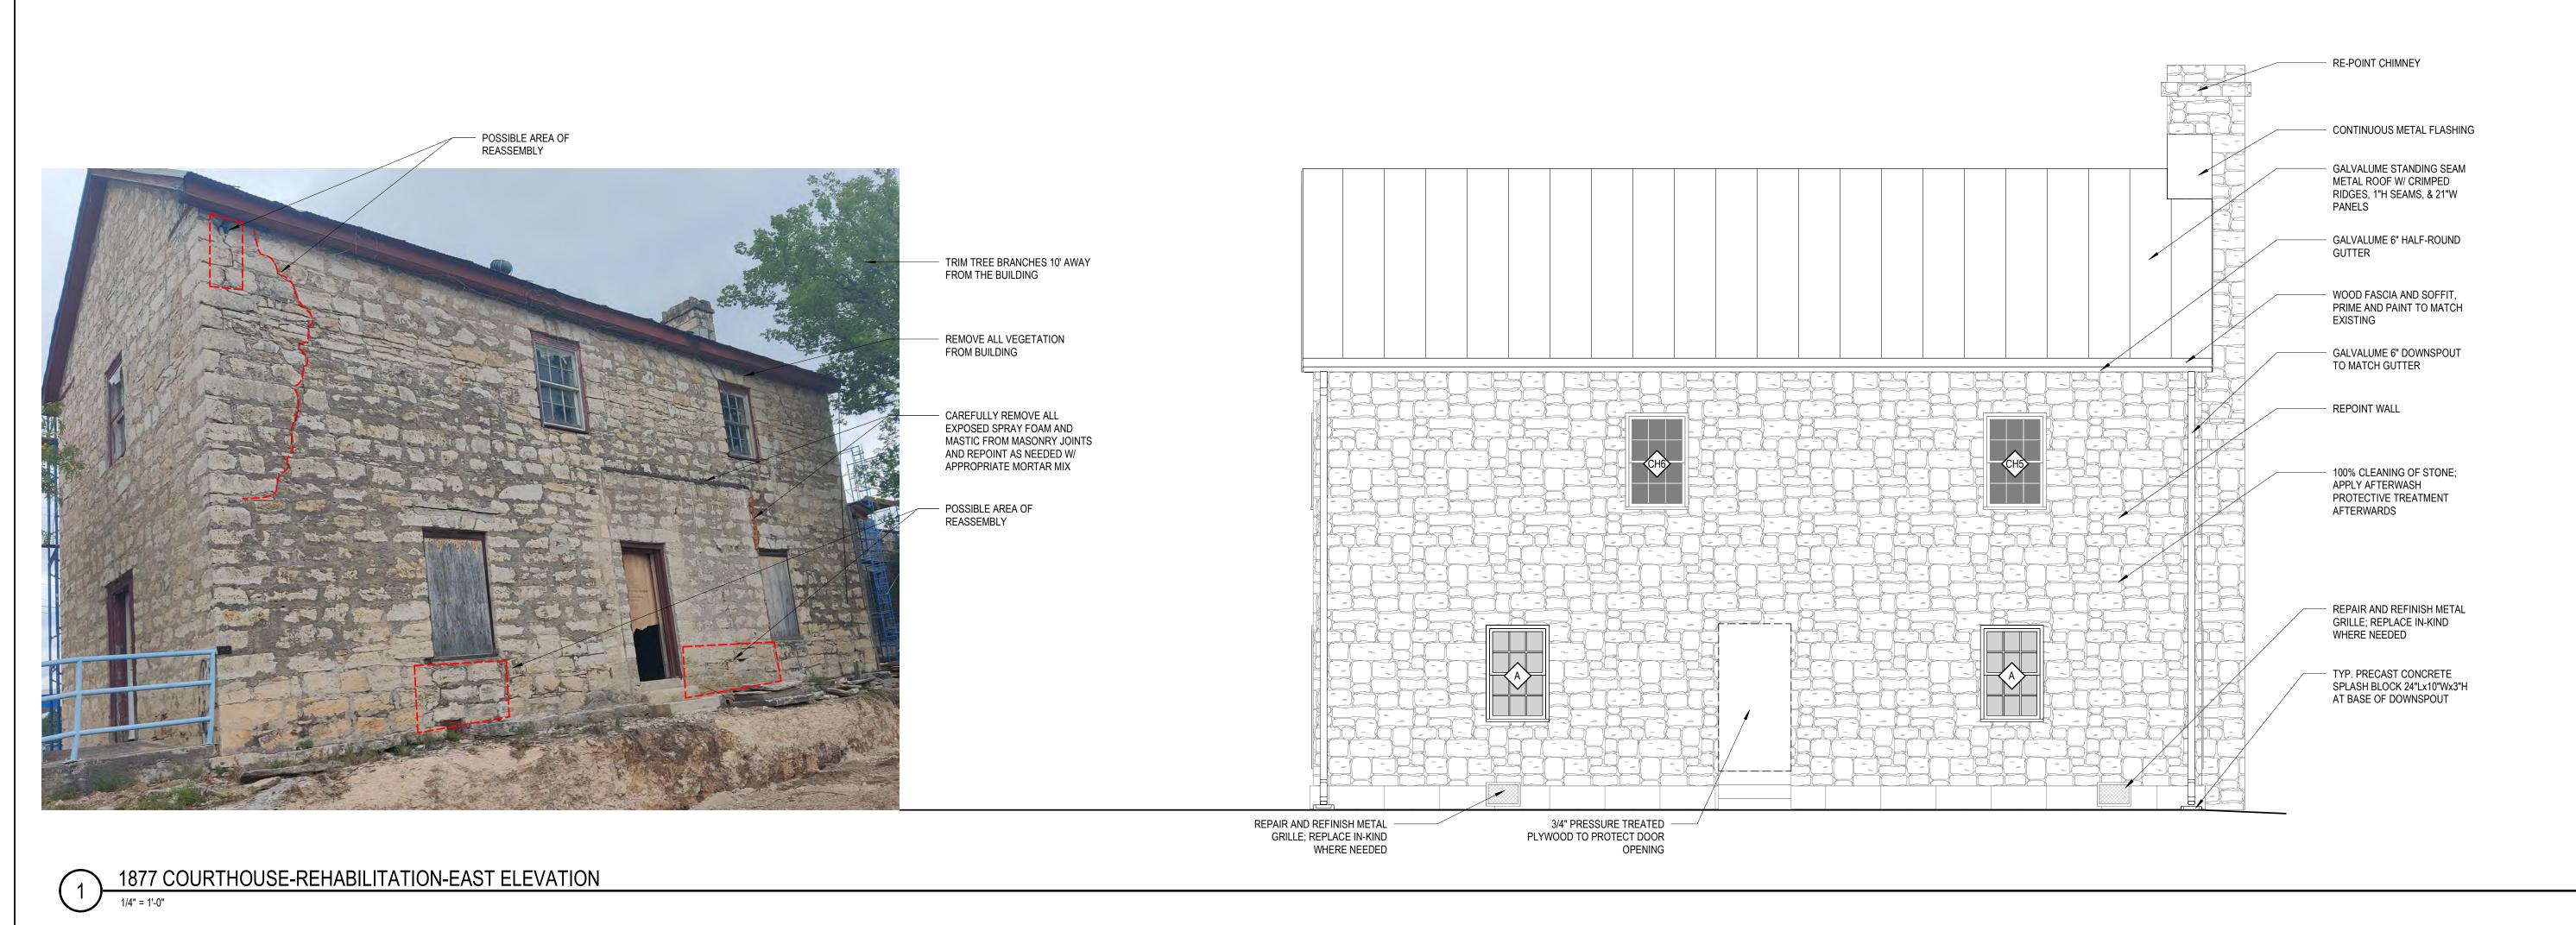- REPOINT WALL

TEMPORARY REMOVE
HISTORICAL PLAQUES AND
SECURELY STORE; PLACE
PLAQUES IN EXACT LOCATION
WHEN STONE WORK IS
COMPLETED



2 1877 COURTHOUSE-REHABILITATION-WEST ELEVATION
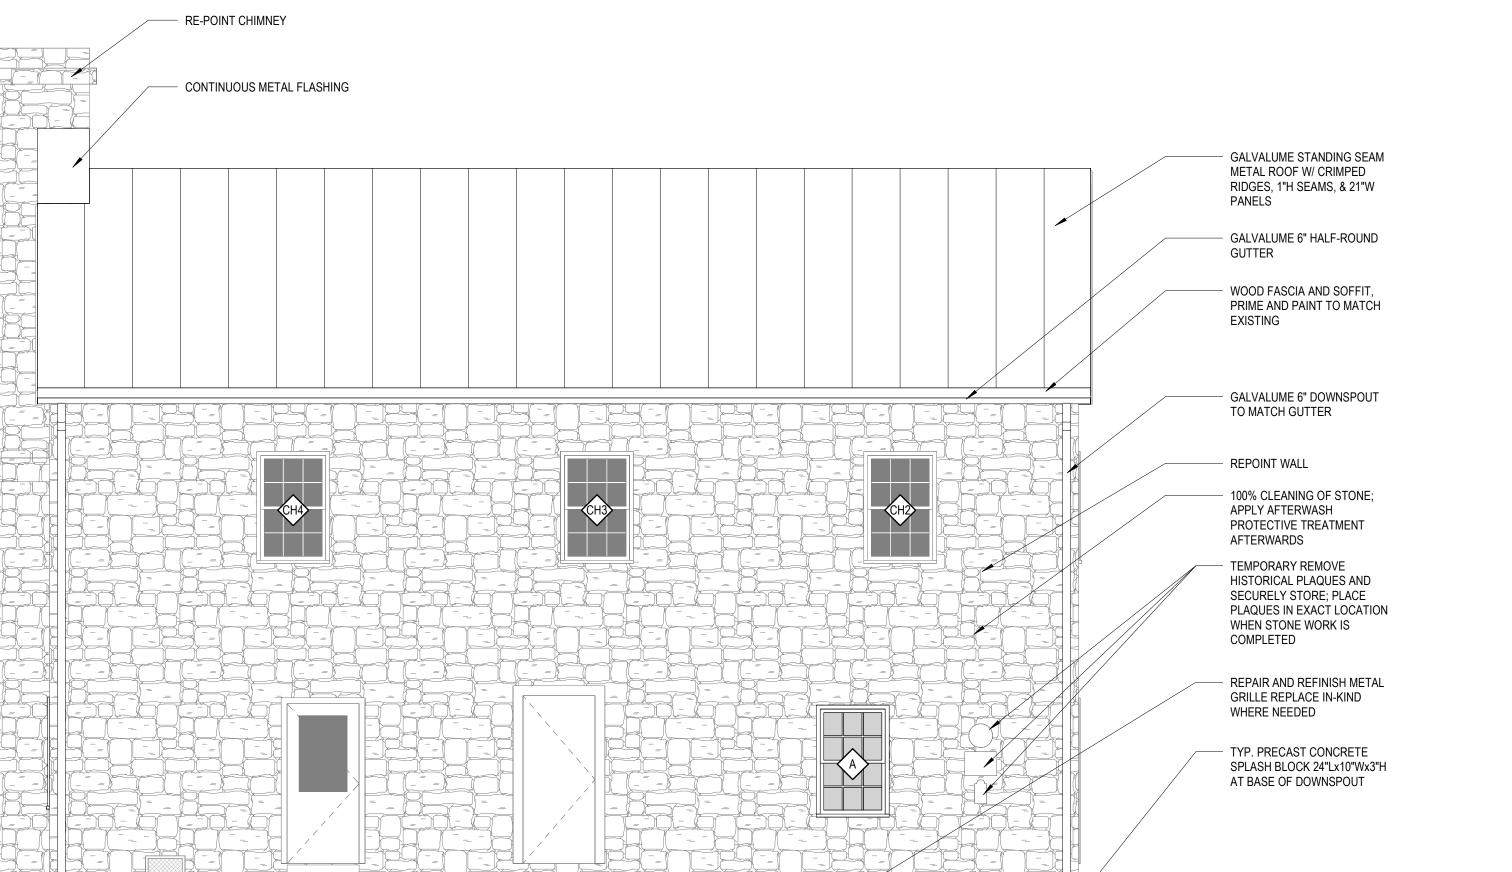
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ELEVATIONS

SHEET TITLE: **EXTERIOR**

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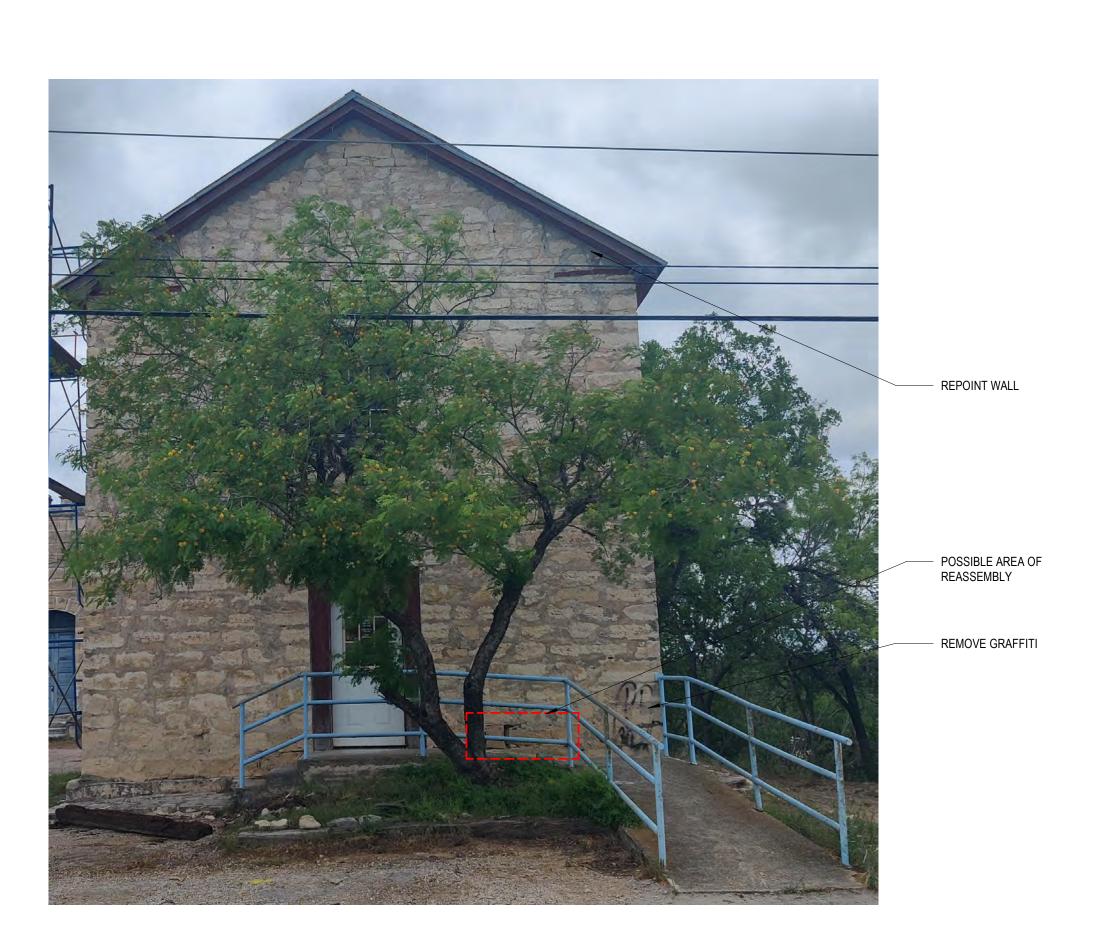
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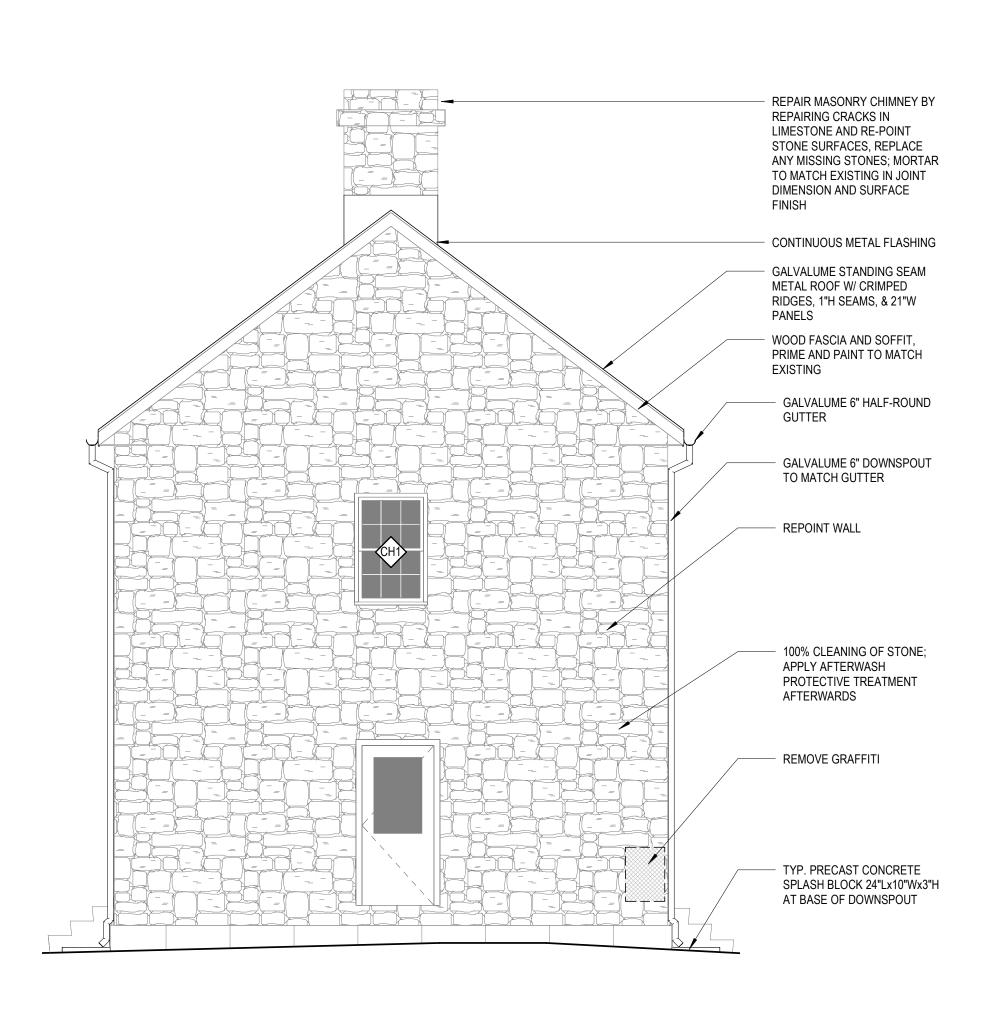
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A-200

REPOINT CHIMNEY GALVALUME STANDING SEAM -METAL ROOF W/ CRIMPED RIDGES, 1"H SEAMS, & 21"W **PANELS** WOOD FASCIA AND SOFFIT, PRIME AND PAINT TO MATCH **EXISTING** GALVALUME 6" HALF-ROUND -GUTTER GALVALUME 6" DOWNSPOUT TO MATCH GUTTER CAREFULLY DECONSTRUCT ROOF REMNANT. VOID WITHIN WALL THAT RESULTS FROM THE REMOVAL OF THE ROOF, SHALL BE FILLED WITH MATCHING STONE WITH A LIME-BASE REPOINT WALL -100% CLEANING OF STONE; UNINSTALL ELECTRICAL TO APPLY AFTERWASH PROTECTIVE TREATMENT REPOINT WALL; ONLY REINSTALL ELECTRICAL NEEDED AFTERWARDS TO CONTINUE WORK 3/4" PRESSURE TREATED -PLYWOOD TO PROTECT DOOR OPENING TYP. PRECAST CONCRETE -SPLASH BLOCK 24"Lx10"Wx3"H AT BASE OF DOWNSPOUT

1) 1877 COURTHOUSE-REHABILITATION-NORTH ELEVATION





2 1877 COURTHOUSE-REHABILITATION-SOUTH ELEVATION

1/4" = 1'-0"

SHEET NO: **A-201**

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BANDERA

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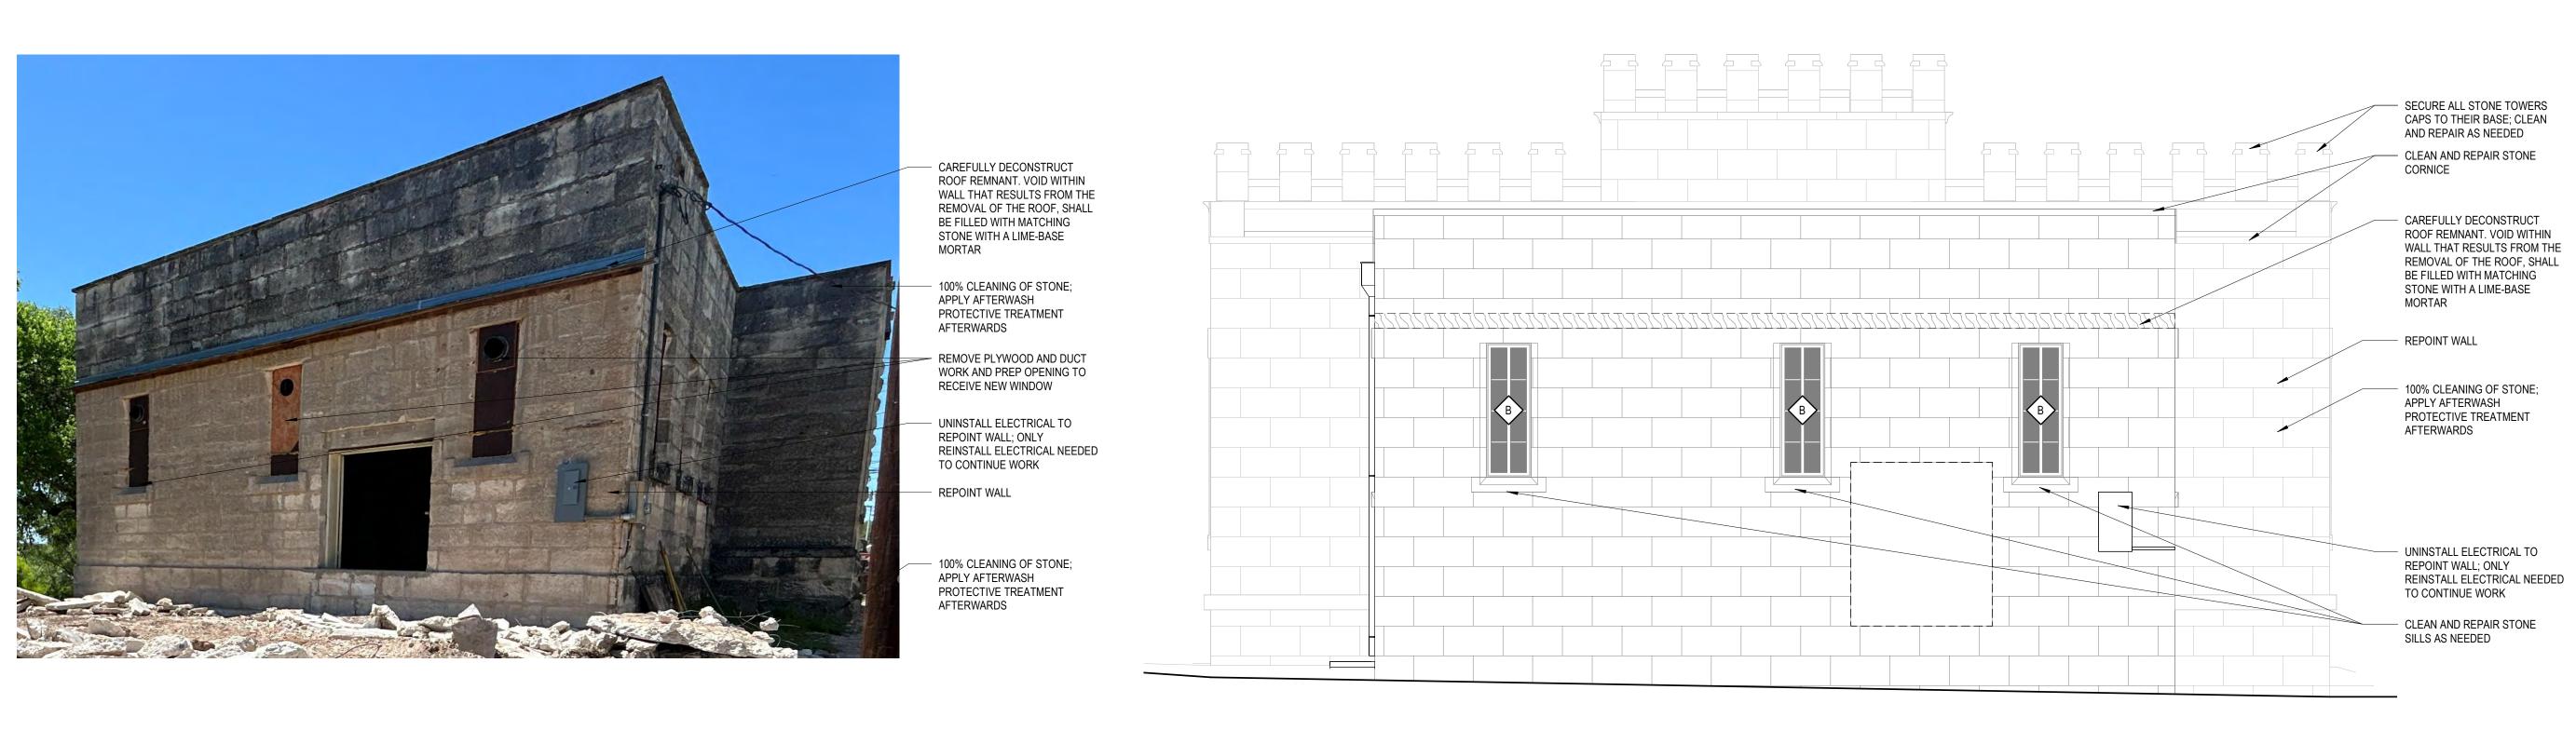
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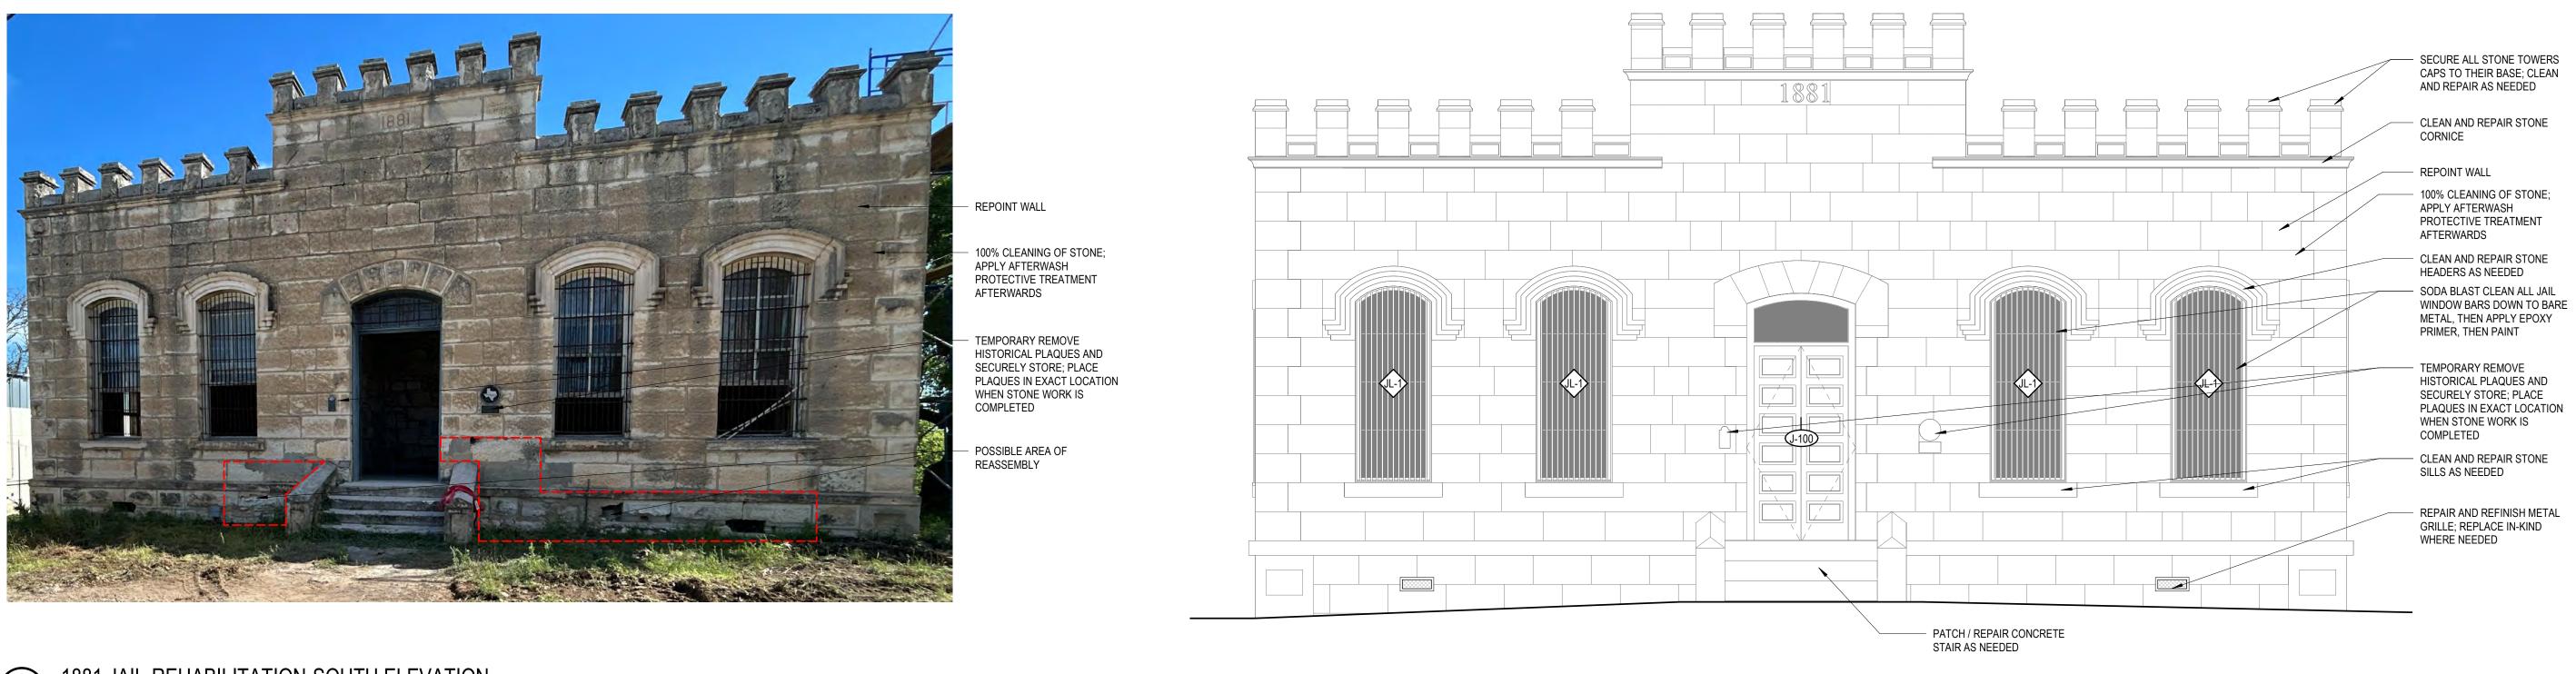
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2 1881 JAIL-REHABILITATION-NORTH ELEVATION



1881 JAIL-REHABILITATION-SOUTH ELEVATION

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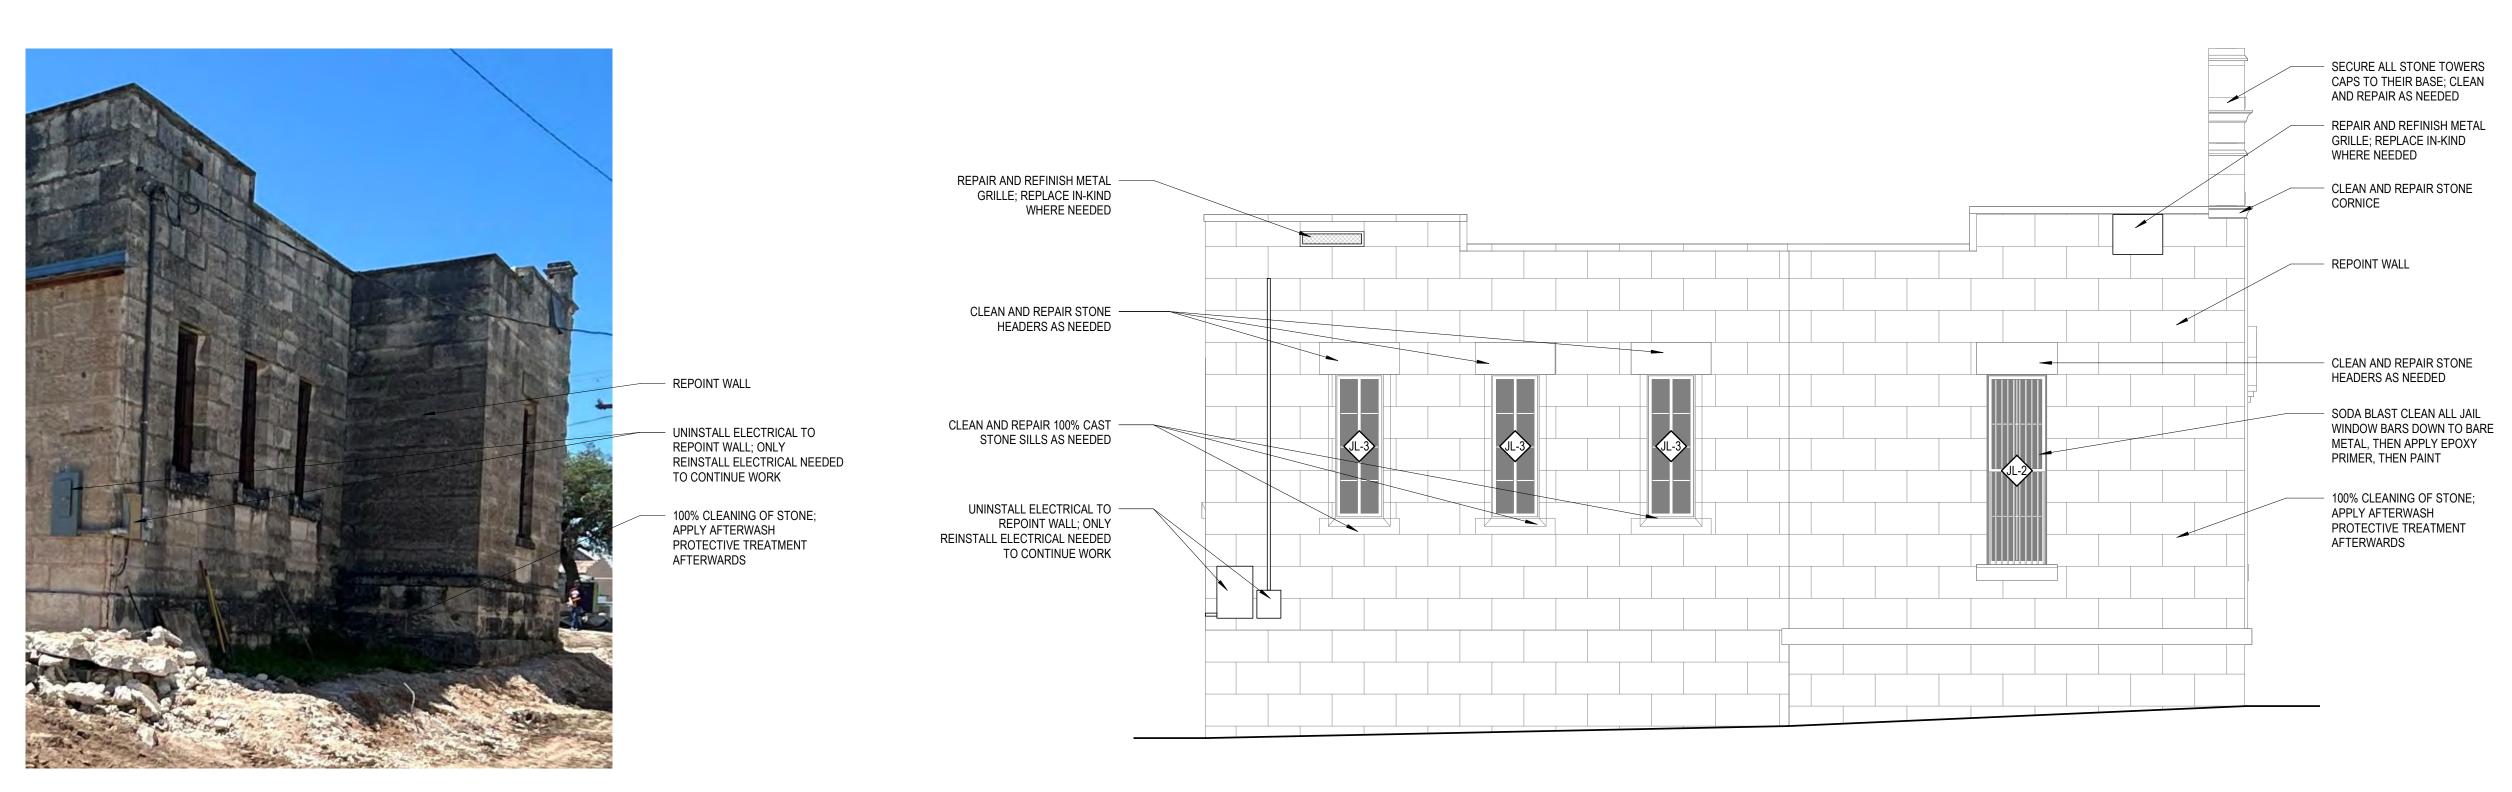
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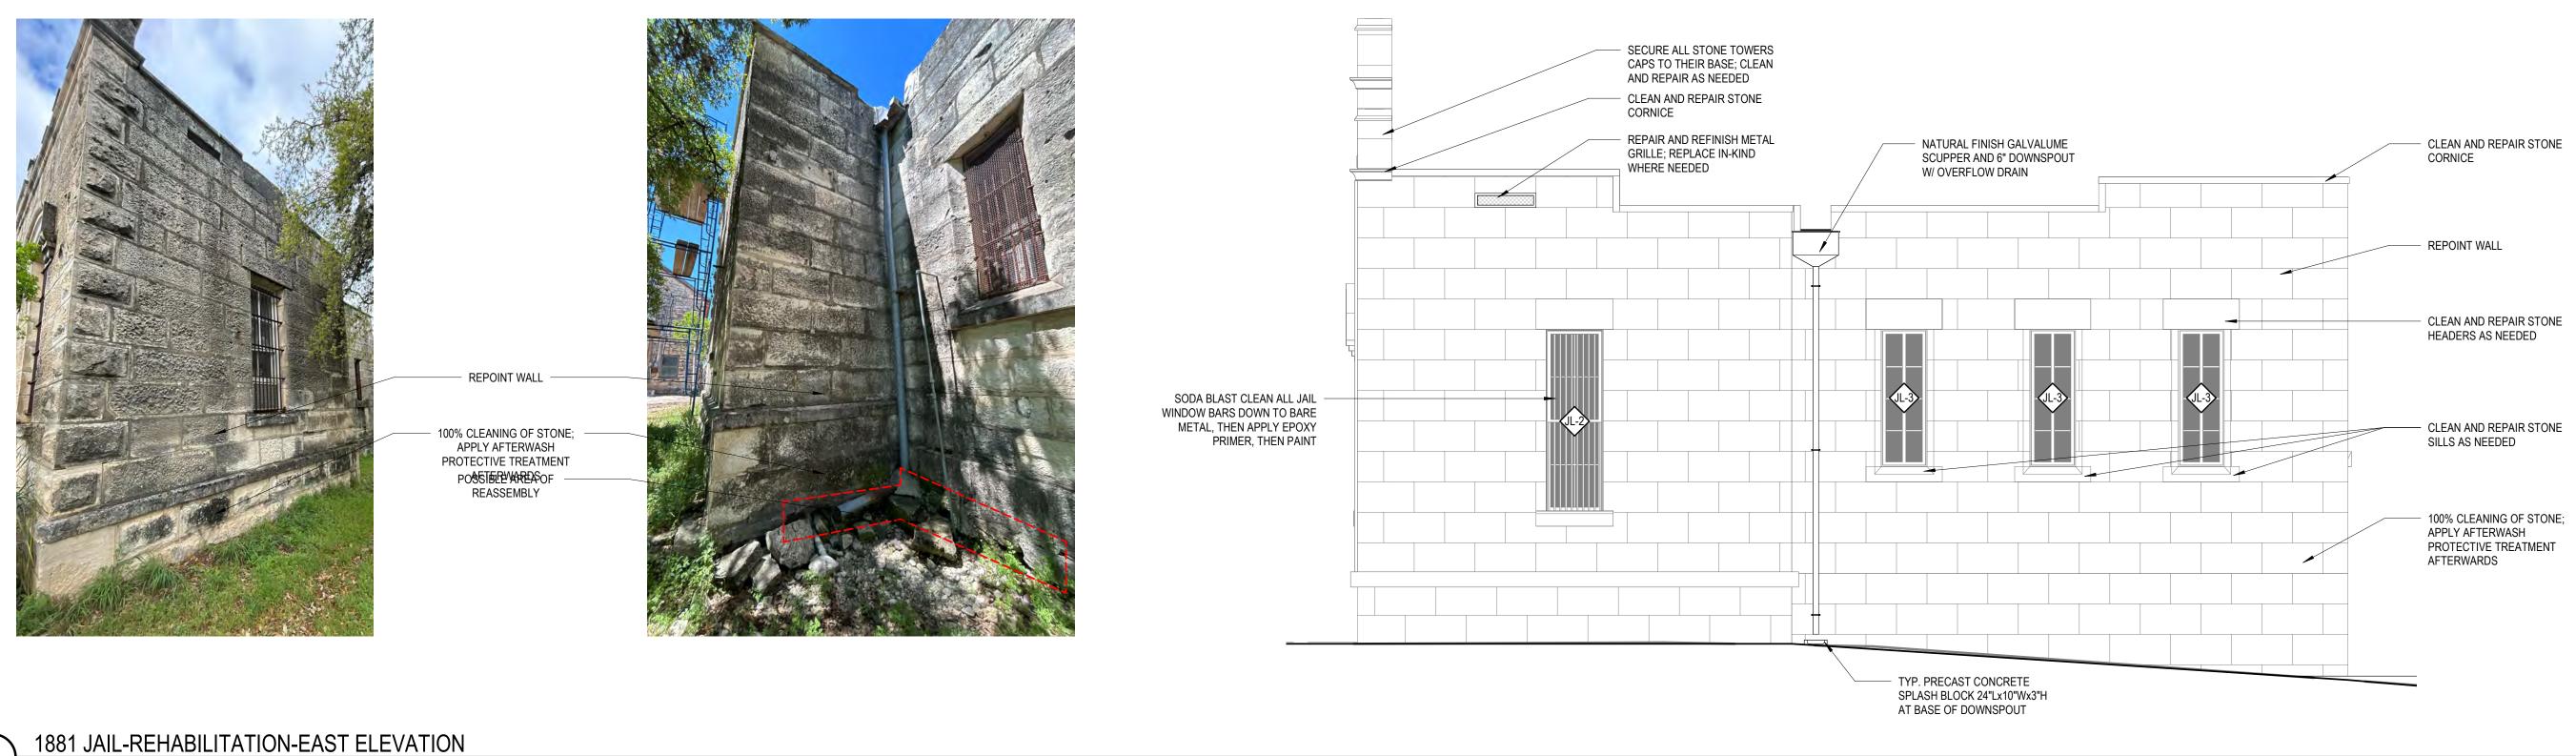
11/01/24

A-210



2 1881 JAIL-REHABILITATION-WEST ELEVATION

1/4" = 1'-0"



1 1

SHEET NO:

COUNTY VISITOR CENTER

BANDERA

PROJECT NO: 2301 A1

 \triangle REVISIONS DATE

1 RE-ISSUE

ELEVATIONS

SHEET TITLE: **EXTERIOR**

11/1/2024

Heck


Fisher

11/01/24

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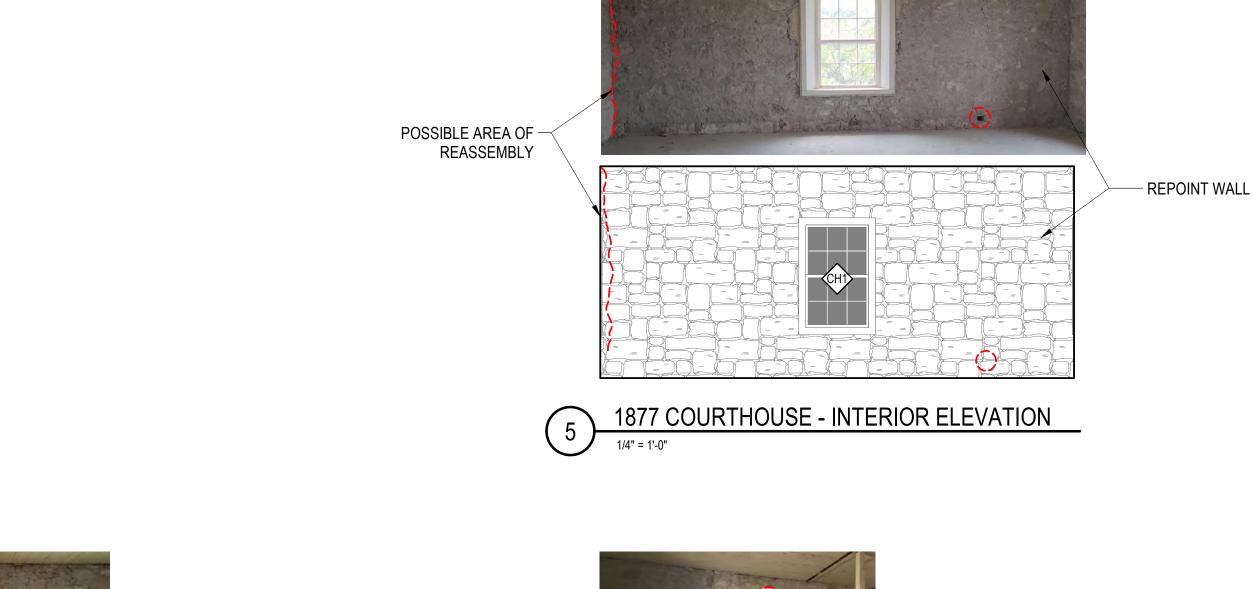
1/2024 1:14:33 PM

A-ZII

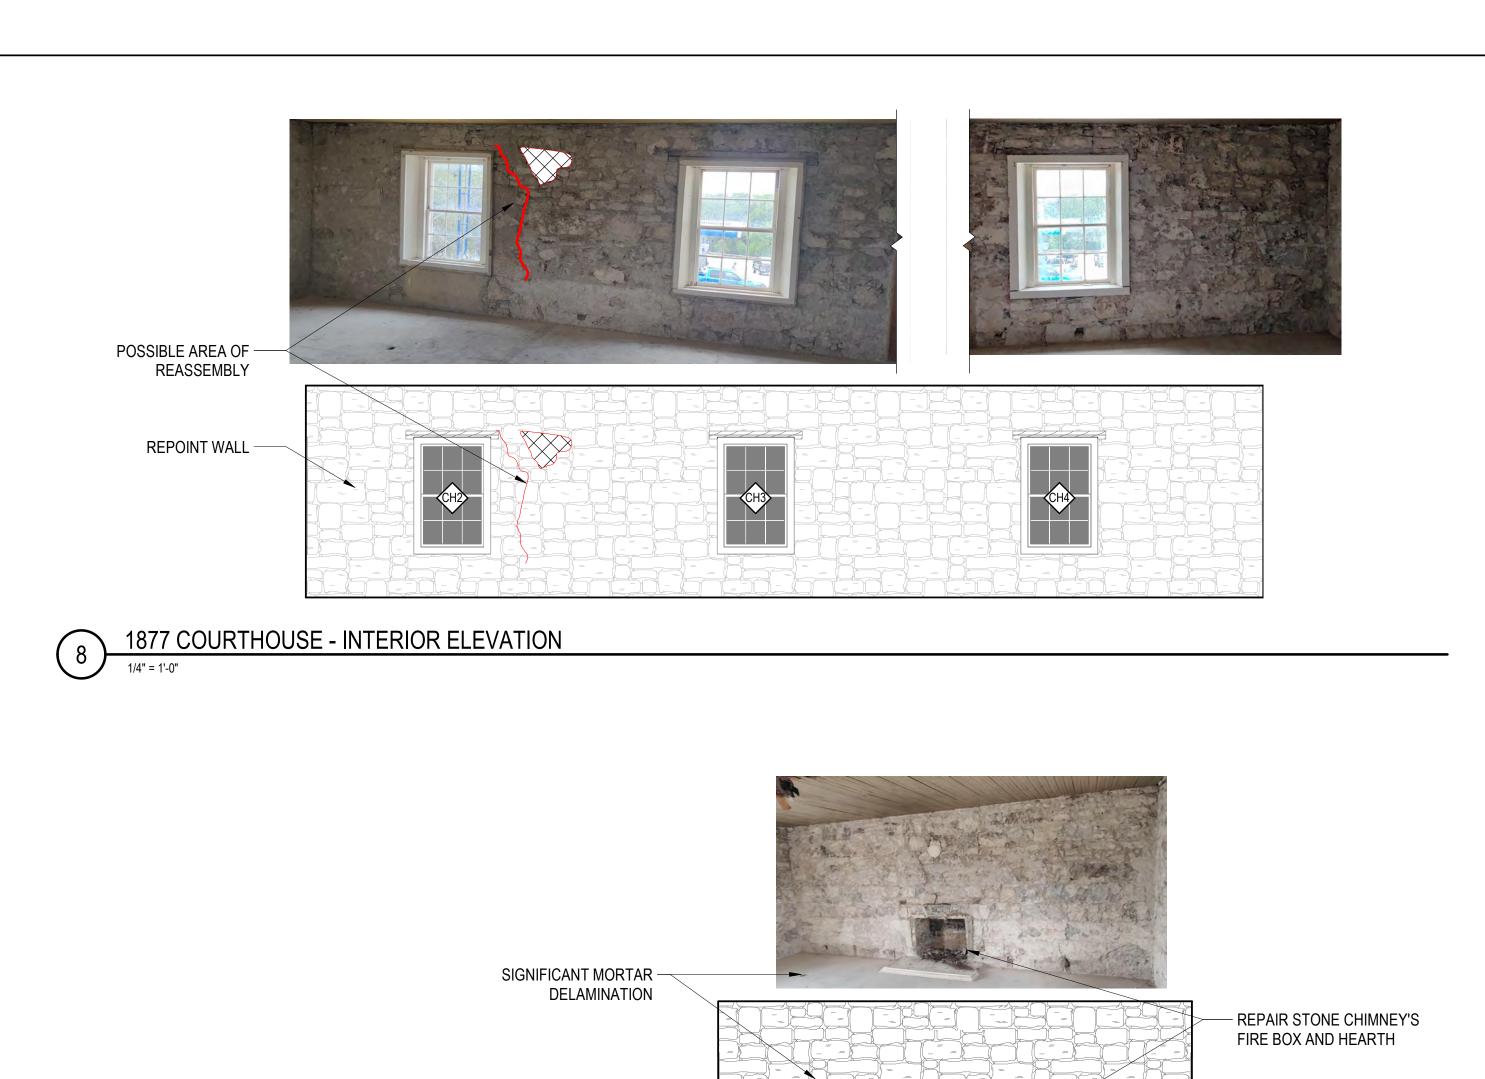


1877 COURTHOUSE - INTERIOR ELEVATION

1/4" = 1'-0"




1877 COURTHOUSE - INTERIOR ELEVATION



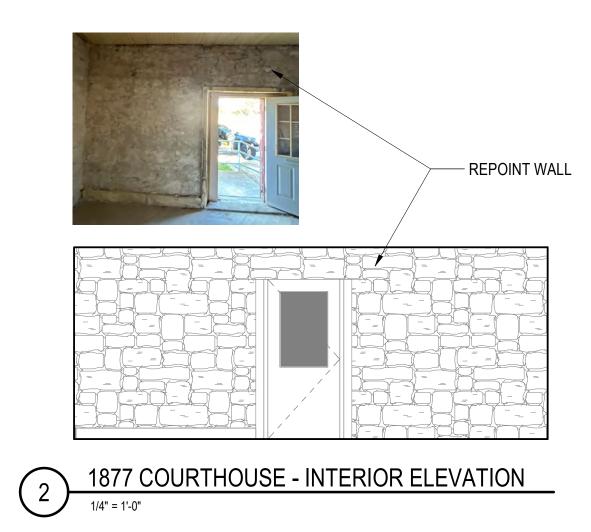

POSSIBLE AREA OF -REASSEMBLY

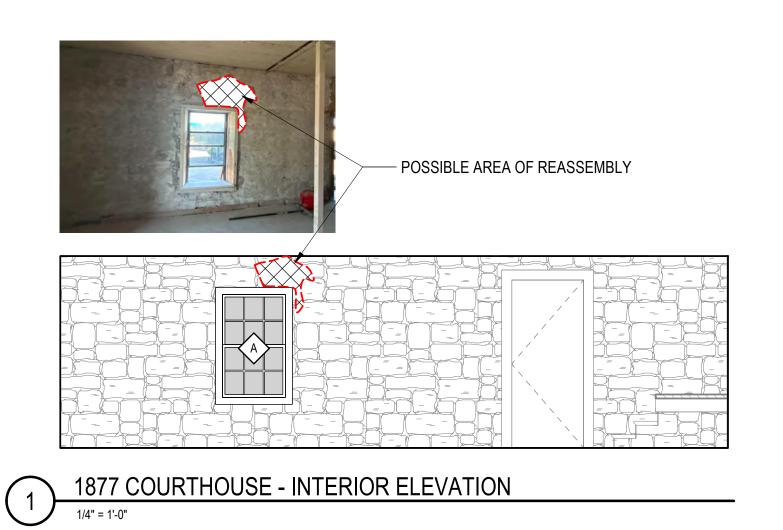

Fisher ARCHIT

— PATCH AIR GAP WITH

STONE IN-KIND

11/01/24


PROJECT NO: 2301 A1

REVISIONS DATE
1 RE-ISSUE 11/1/2024

11/1/2024

BANDERA COUNTY VISITOR CENTER

SHEET TITLE:
ENLARGED ELEVATIONS

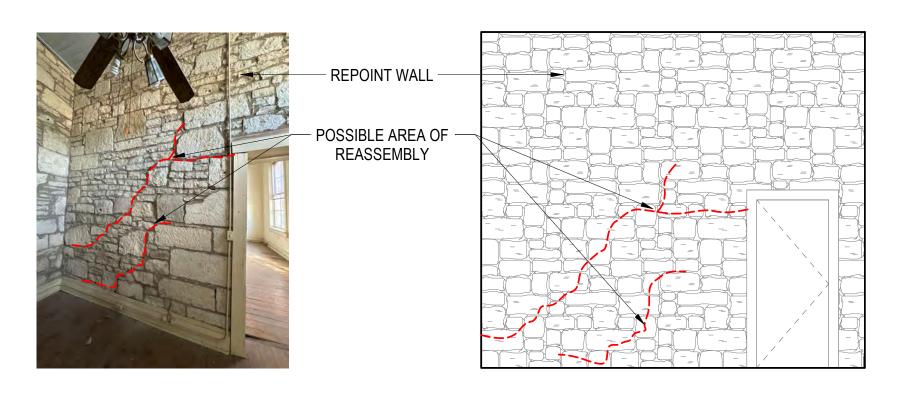


1881 JAIL - INTERIOR ELEVATION

1/4" = 1'-0"




2 1881 JAIL - INTERIOR ELEVATION

1/4" = 1'-0"

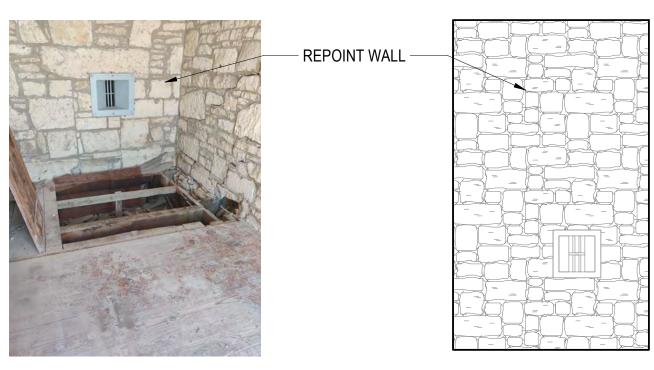


3 1881 JAIL - INTERIOR ELEVATION

1/4" = 1'-0"

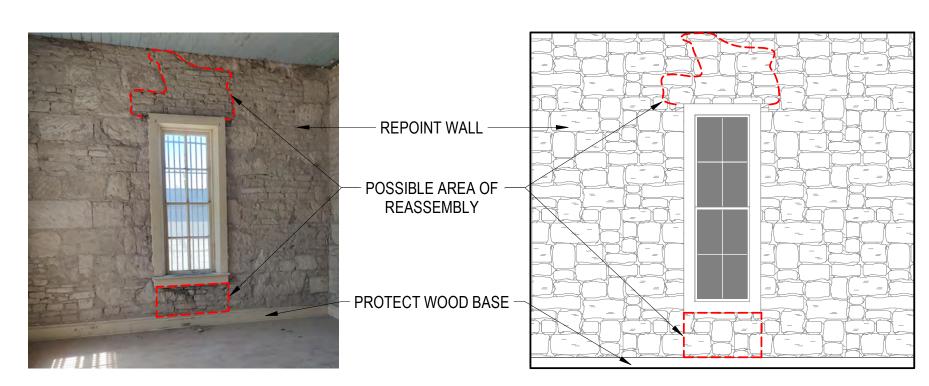


4 1881 JAIL - INTERIOR ELEVATION

1/4" = 1'-0"

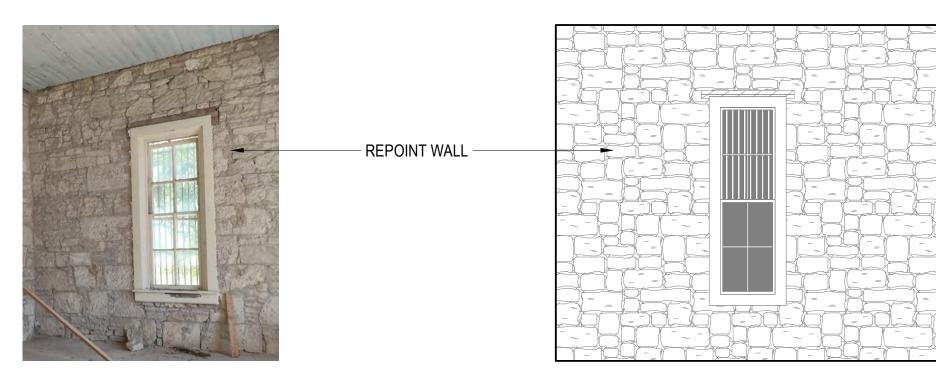


5 1881 JAIL - INTERIOR ELEVATION


1/4" = 1'-0"

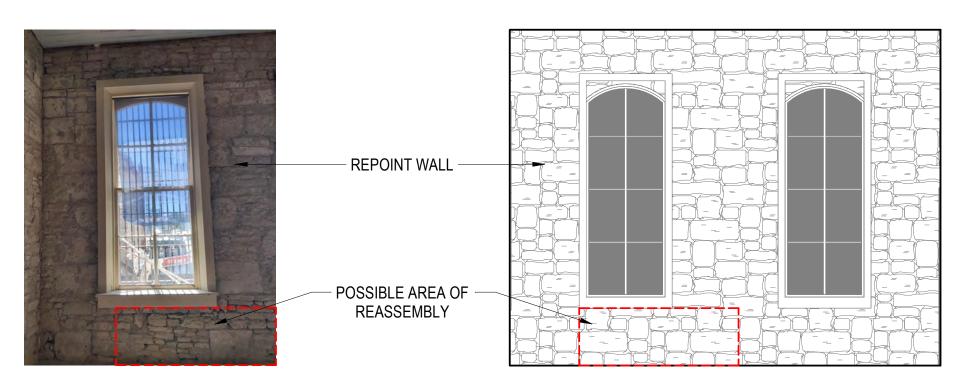

6 1881 JAIL - INTERIOR ELEVATION

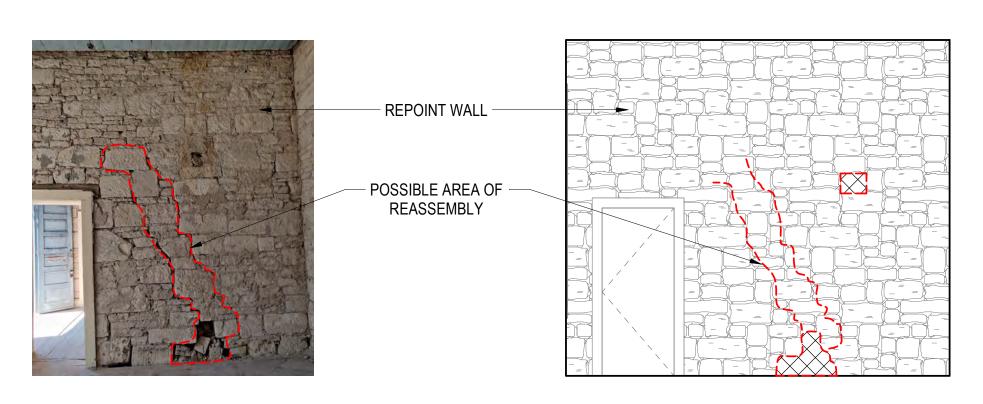

7 1881 JAIL - INTERIOR ELEVATION

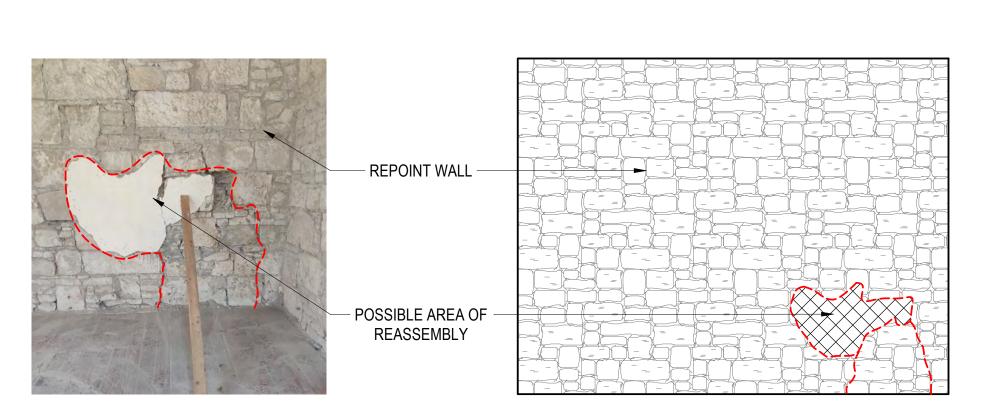

8 1881 JAIL - INTERIOR ELEVATION

1/4" = 1'-0"

FISHER HECK T S AN ANTONIO TEXAS FISHER HECK.COM 210-299-1500

BANDERA COUNTY VISITOR CENTER SHETTINE:
ENLARGED ELEVATIONS

PROJECT NO: 2301 A1

A REVISIONS DATE
1 RE-ISSUE 11/1/2024

SHEET NO:

A-410



4 1881 JAIL - INTERIOR ELEVATION

1/4" = 1'-0"

– PROTECT WINDOWS – AND WOOD SHUTTERS

3 1881 JAIL - INTERIOR ELEVATION

1/4" = 1'-0"

REPOINT WALL

PROTECT WINDOWS – AND WOOD SHUTTERS

2 1881 JAIL - INTERIOR ELEVATION

1/4" = 1'-0"



1881 JAIL - INTERIOR ELEVATION

1/4" = 1'-0"

SHEET NO:

PROJECT:


BANDERA COUNTY VISITOR CENTER


SHEET TITLE:
ENLARGED ELEVATIONS


Fisher Heck


PROJECT NO: 2301 A1

A REVISIONS DATE
1 RE-ISSUE 11/1/2024

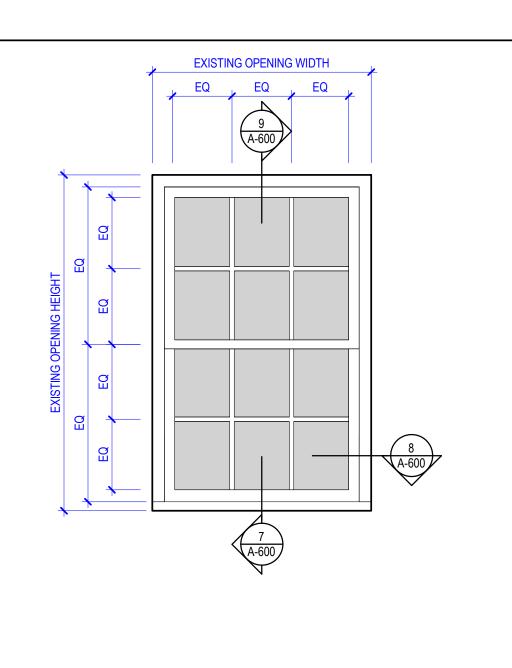

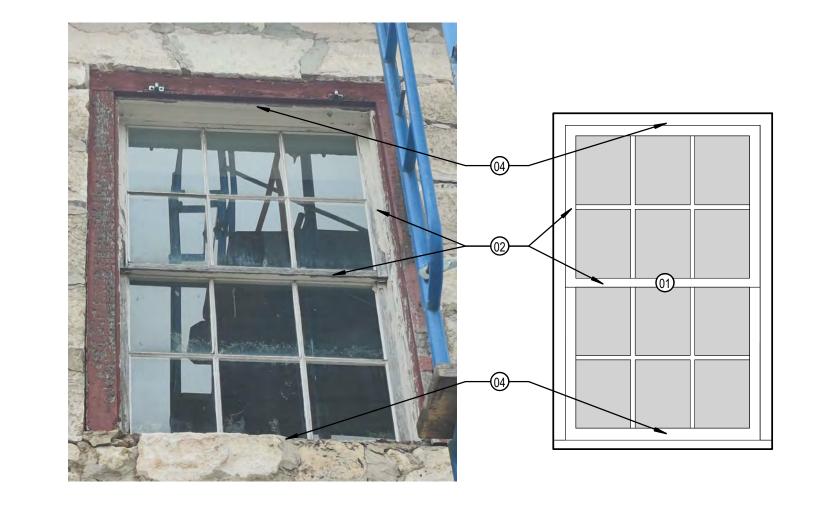

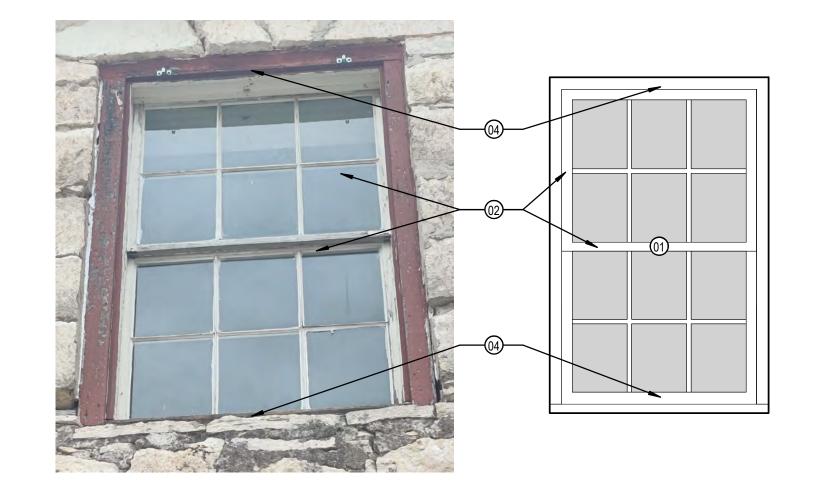

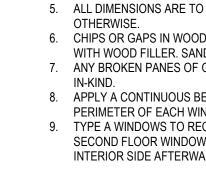

01 REPLACE ROTTED COMPONANTS WITHIN FRAME AS NEEDED WIT

NEW COAT OF PAINT. PATCH/REPAIR CRACKS AND HOLES WITH PUTTY. ANY ROTTED COMPONENTS TO BE REPLACED WITH WOOD, IN-KIND, MATCHING SPECIES. 03 STRIP AND PREPARE CASING, STOOL, AND APRON TO RECEIVE

CRACKS AND HOLES WITH PUTTY. ANY ROTTED COMPONENTS TO BE REPLACED WITH WOOD, IN-KIND, MATCHING SIZE AND 04 STRIP AND PREPARE WINDOW FRAMES, SILLS, SASHES, AND TRIM

WITH PUTTY. ANY ROTTED COMPONENTS TO BE REPLACED WITH WOOD, IN-KIND, MATCHING SIZE AND SPECIES. 05 REPAIR DAMAGED STILES.

REPLACE MISSING CASING WITH WOOD, IN-KIND, MATCHING SIZE

08 REPLACE BROKEN GLASS, REPLACE WITH NEW TEMPERED GLASS

METAL, THEN APPLY EPOXY PRIMER, THEN PAINT

NEW PAINT. PATCH/REPAIR CRACKS AND HOLES WITH PUTTY. ANY ROTTED COMPONENTS TO BE REPLACED WITH WOOD, IN-KIND, MATCHING SIZE AND SPECIES. REPLACE GLASS PANES IN-KIND.

REPAIR EXISTING TRANSOM FRAME / GLASS; REMOVE EXISTING PANES, REPLACE WITH NEW TEMPERED GLASS, IN-KIND. REPLACE DAMAGED WOOD COMPONANTS, IN-KIND, AS NEEDED. SAND,


12 REPAIR / REPLACE DAMAGED DOOR COMPONENTS AS NEEDED WITH WOOD, IN-KIND, MATCHING SIZE AND SPECIES. SAND, PREP,

REPLACE DAMAGED. DETERIORATED. OR MISSING


DAMAGED RECESSED PANELS TO BE REPLACED IN-KIND TO MATCH EXISTING IN SIZE AND SPECIES; SAND, PREP, AND PAINT

WINDOWS INKIND, SIZE AND SPECIES.

17 NEW HARDWARE, MATCH EXISTING IN-KIND. 18 DEMO PLYWOOD AND DUCT WORK TO REVEAL JAIL BARS; CAREFULLY REMOVE ALL EXPOSED SPRAY FOAM AND MASTIC

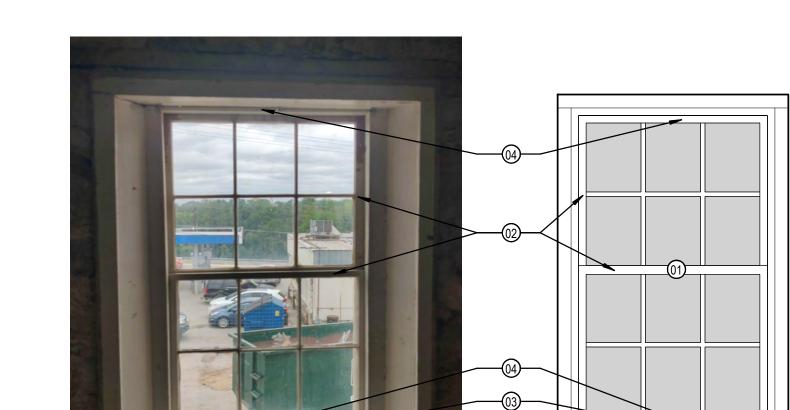


CH-2 INTERIOR
3/4" = 1'-0"

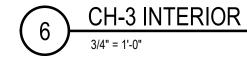

- EXISTING LIMESTONE

CH-3 EXTERIOR

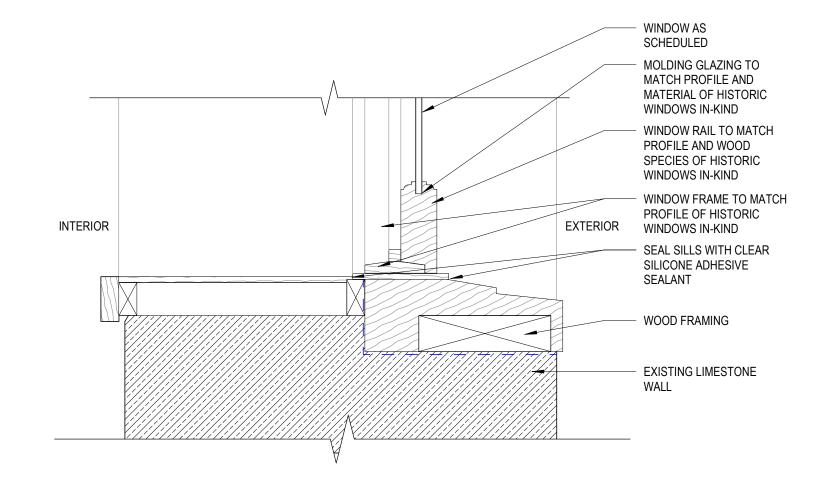

CH-1 INTERIOR

WINDOW SILL DETAIL

WALL **EXTERIOR** WINDOW STILE TO MATCH PROFILE AND WOOD SPECIES OF HISTORIC WINDOWS IN-KIND WINDOW AS SCHEDULE MOLDING GLAZING TO MATCH PROFILE AND MATERIAL OF HISTORIC WINDOWS IN-KIND WINDOW FRAME TO MATCH PROFILE AND WOOD SPECIES OF HISTORIC WINDOWS IN-KIND WOOD FRAMING INTERIOR

EXISTING LIMESTONE WALL EXISTING WD. LINTEL WINDOW FRAME TO MATCH PROFILE AND WOOD SPECIES OF HISTORIC WINDOWS IN-KIND WINDOW RAIL TO MATCH PROFILE AND WOOD SPECIES OF HISTORIC WINDOWS IN-KIND MOLDING GLAZING TO MATCH PROFILE AND MATERIAL OF HISTORIC EXTERIOR WINDOWS IN-KIND INTERIOR WINDOW AS SCHEDULE

WINDOW HEAD DETAIL

WINDOW JAMB DETAIL

GENERAL NOTES

1. IMMEDIATELY ON DISCOVERY OF THE NEED FOR CLARIFICATION OF THE CONTRACT DOCUMENTS, SUBMIT A REQUEST FOR

INFORMATION TO ARCHITECT. 2. THESE DOCUMENTS SHOULD NO BE CONSIDERED AS A SURVEY OF EXISTING CONDITIONS. THE GENERAL CONTRACTOR SHALL NOTIFY ARCHITECT IMMEDIATELY OF ANY DISCREPANCIES OR

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DETAILS

REHABILITATION

SHEET TITLE: WINDOW

11/1/2024

CENTER

VISITOR

OMISSIONS BETWEEN DOCUMENTS AND FIELD CONDITIONS BEFORE COMMENCING ANY WORK AND REQUEST CLARIFICATION. 3. ELEMENTS NOTED WITHIN KEYNOTES ARE BASED UPON VISUAL OBSERVATIONS AT THE TIME OF SURVEY, CONTRACTOR TO VERIFY ANY ADDITIONAL SUBSEQUENT DAMAGE THAT MAY HAVE OCCURED. CONTRACTOR TO ASSUME 30% REPLACEMENT OF ELEMENTS IN-KIND FOR EACH WINDOW FOR PURPOSES OF BID AND VERIFY ON-SITE ANY ELEMENTS THAT ARE ROTTED, BROKEN SPLIT OR MISSING SHALL BE REPLACED IN-KIND.

4. FIELD VERIFY ALL EXISTING DIMENSIONS, ELEVATIONS, & CONDITIONS PRIOR TO COMMENCEMENT OF WORK.

5. ALL DIMENSIONS ARE TO FACE OF MATERIAL UNLESS NOTED 6. CHIPS OR GAPS IN WOOD UNDER ONE-INCH MAY BE REPAIRED

WITH WOOD FILLER. SAND, PREP & PAINT TO MATCH. 7. ANY BROKEN PANES OF GLASS TO BE REPLACED & REGLAZED

8. APPLY A CONTINUOUS BEAD OF CLEAR SEALANT AROUND PERIMETER OF EACH WINDOW FRAME.

9. TYPE A WINDOWS TO RECEIVE HARDWARE MATCHING HISTORIC SECOND FLOOR WINDOWS IN-KIND. SCREW FRAMES SHUT FROM INTERIOR SIDE AFTERWARDS.

KEYNOTES

WOOD, IN-KIND, MATCHING SIZE, SPECIES, AND PROFILE. SAND, PREP, AND PAINT ALL WOOD SURFACES. 02 STRIP AND PREPARE STILES, MULLIONS, AND RAILS TO RECEIVE

NEW COAT OF PAINT TO MATCH EXISTING. PATCH/REPAIR

TO RECEIVE NEW PAINT. PATCH/REPAIR CRACKS AND HOLES

06 STRIP AND RECONDITION HARDWARE FOR REUSE.

AND SPECIES.

09 SODA BLAST CLEAN ALL JAIL WINDOW BARS DOWN TO BARE

10 STRIP AND PREPARE INTERIOR WINDOW SCREEN TO RECEIVE

PREP, AND PAINT ALL WOOD SURFACES.


AND PAINT ALL WOOD SURFACES.


WEATHERSTRIPPING AND INSTALL ADA METAL THRESHOLD. NEW WOOD SURFACES TO MATCH EXISTING WOOD SURFACES


15 CONSTRUCT REPLICA WINDOW MATCH ADJACENT WOOD


NEW TEMPERED GLASS, MATCH EXISTING IN-KIND.


COUNTY **BANDERA** PROJECT NO: 2301 A1 A REVISIONS DATE 1 RE-ISSUE

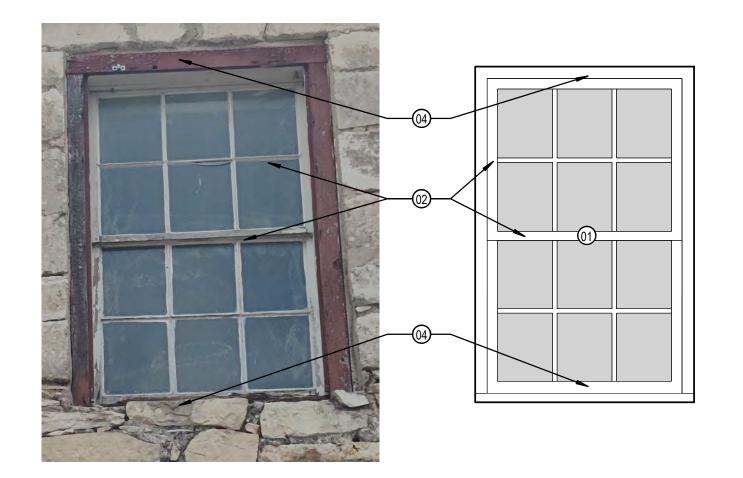


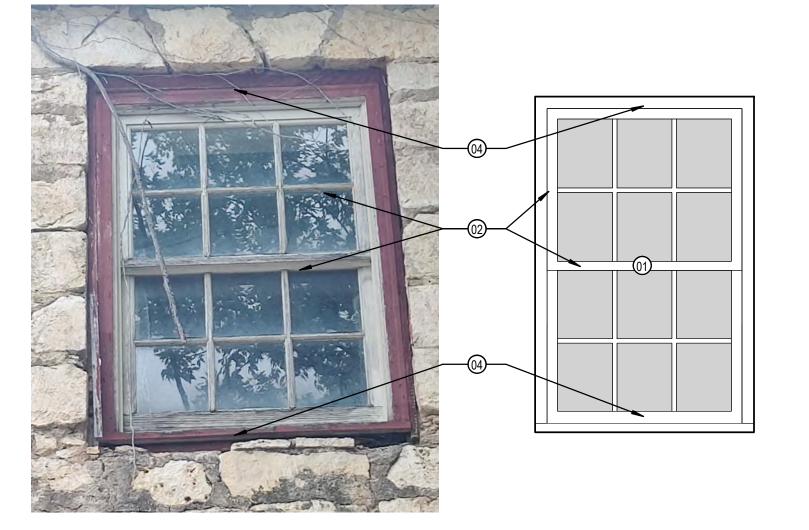


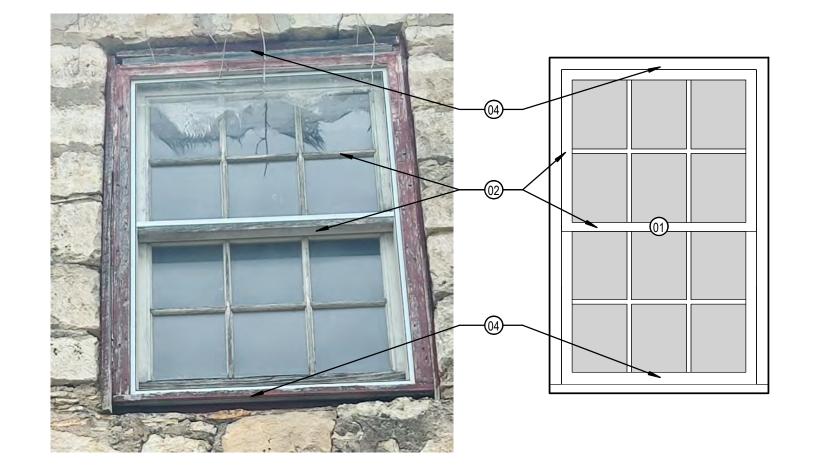


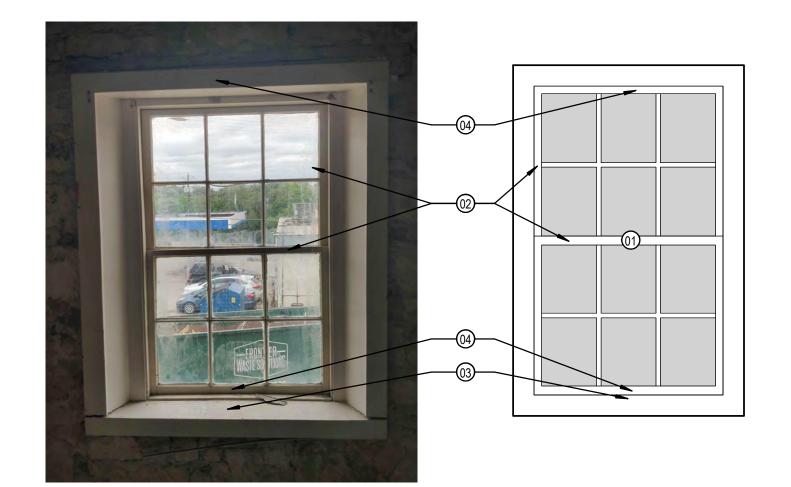

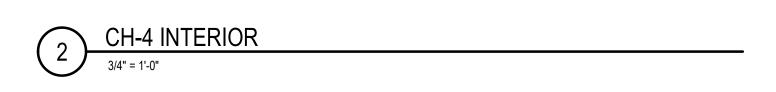

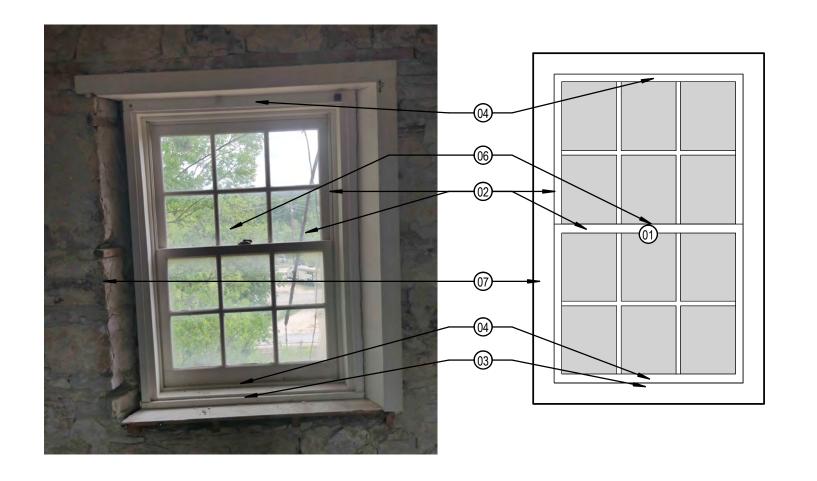

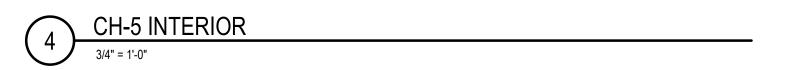

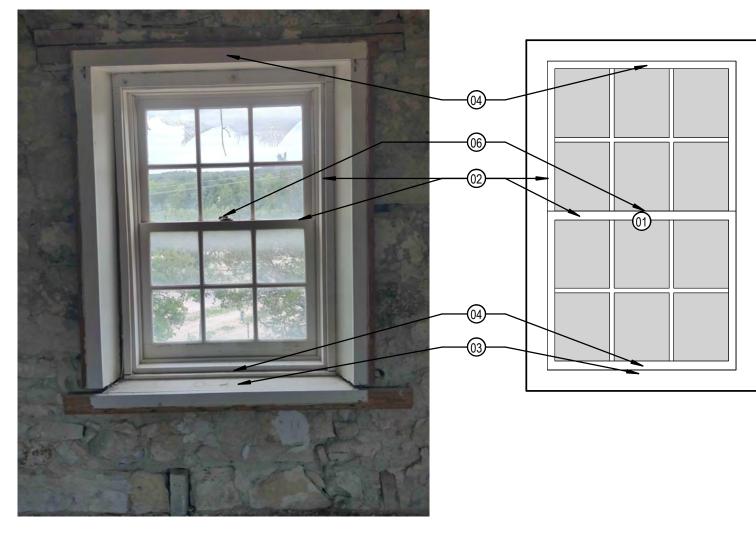

6 CH-6 INTERIOR

3/4" = 1'-0"

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- 14 DAMAGED RECESSED PANELS TO BE REPLACED IN-KIND TO MATCH EXISTING IN SIZE AND SPECIES; SAND, PREP, AND PAINT NEW WOOD SURFACES TO MATCH EXISTING WOOD SURFACES
- 15 CONSTRUCT REPLICA WINDOW MATCH ADJACENT WOOD WINDOWS INKIND, SIZE AND SPECIES.
- 16 NEW TEMPERED GLASS, MATCH EXISTING IN-KIND.
- 17 NEW HARDWARE, MATCH EXISTING IN-KIND.
- 18 DEMO PLYWOOD AND DUCT WORK TO REVEAL JAIL BARS; CAREFULLY REMOVE ALL EXPOSED SPRAY FOAM AND MASTIC

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11/01/24

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877 SHEET TITLE:
WINDOW REHABILITATION DETAILS


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COUNTY VISITOR


BANDERA


PROJECT NO: 2301 A1

A REVISIONS DATE 1 RE-ISSUE 11/1/2024

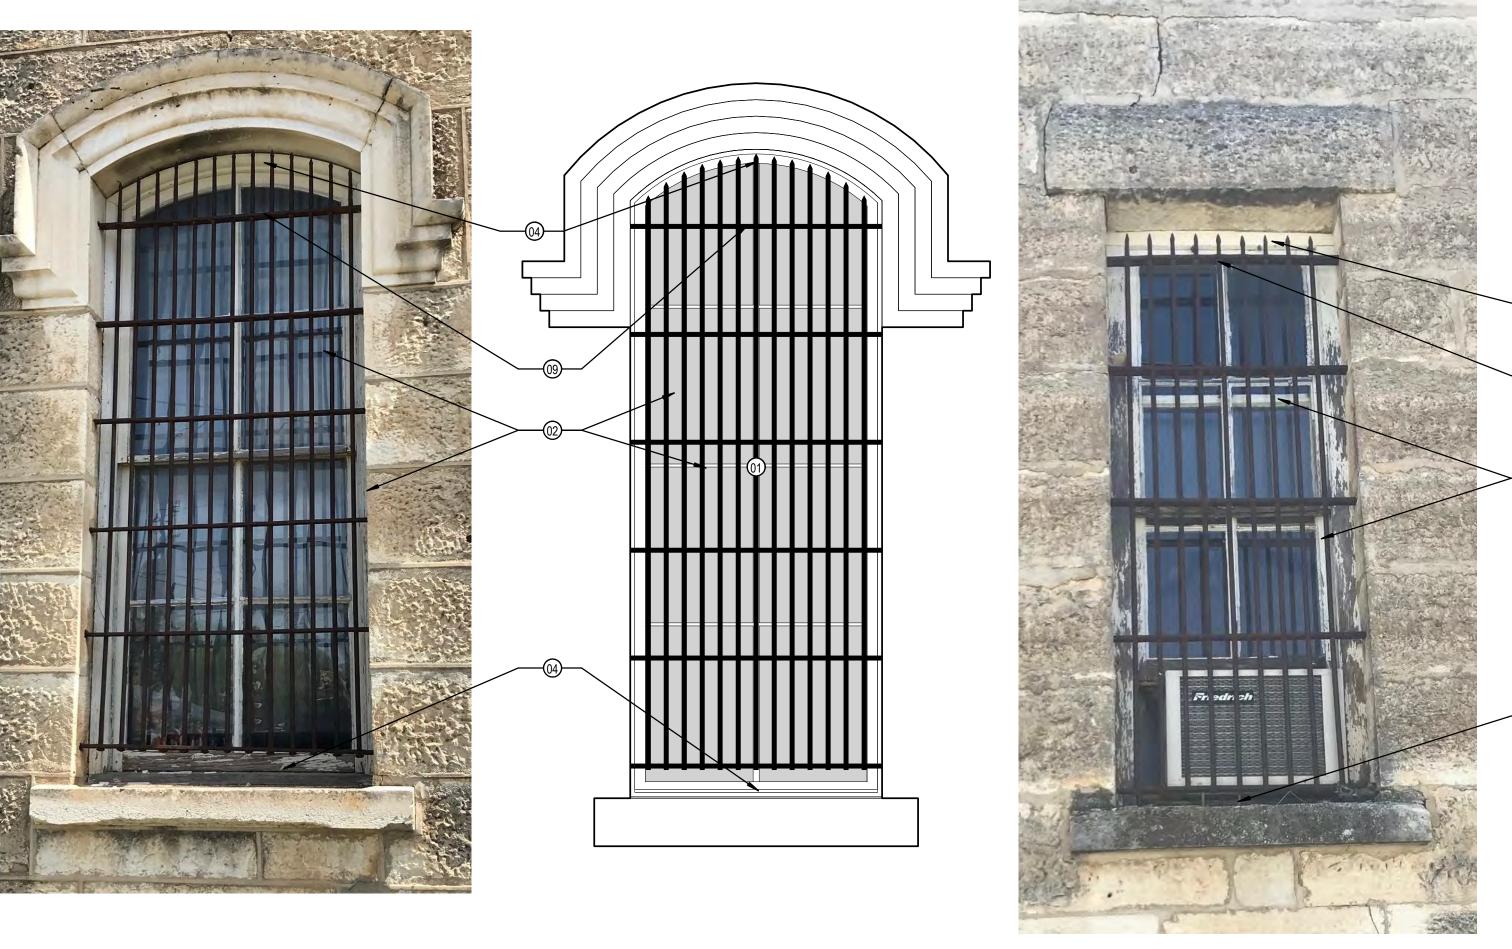

JL-2 EXTERIOR

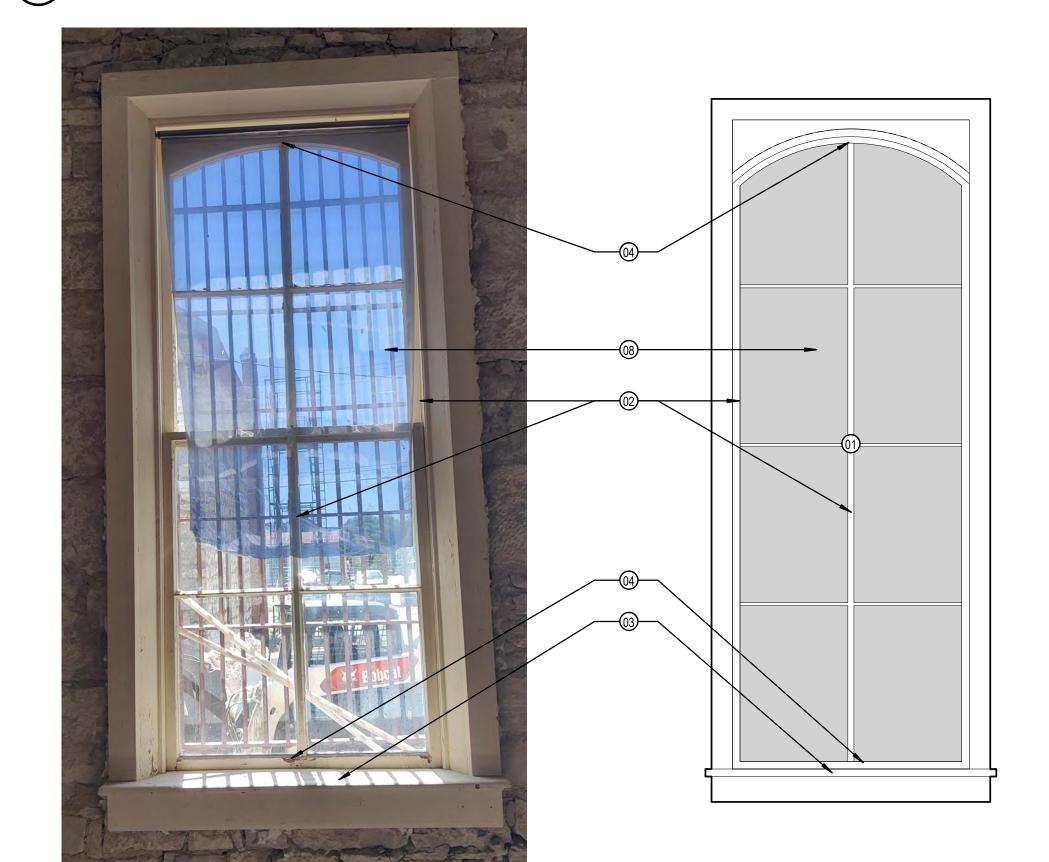

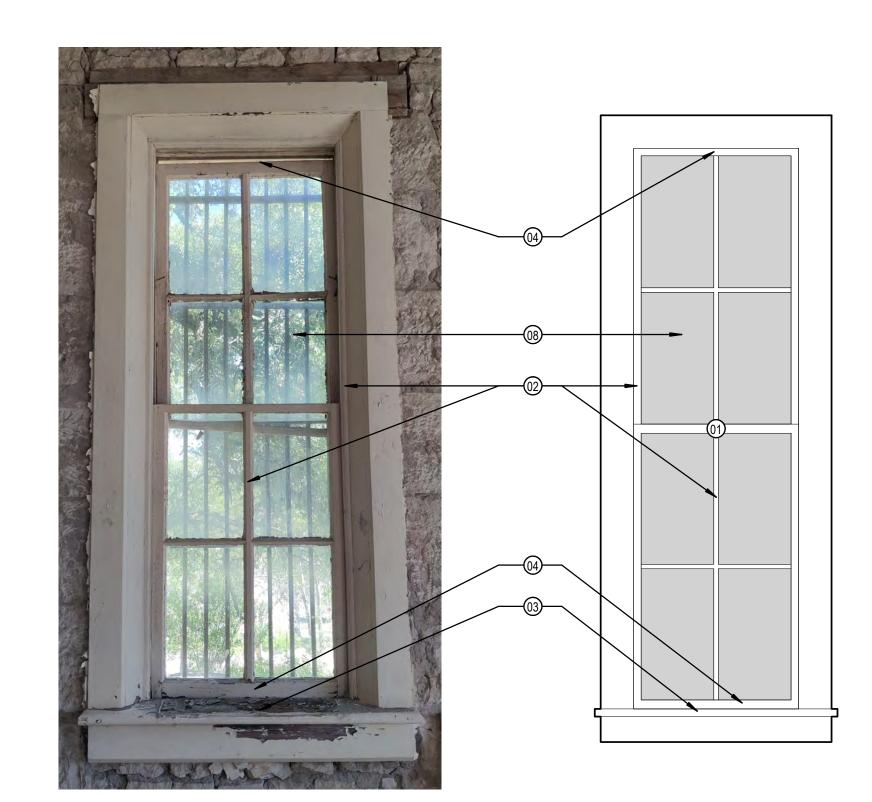


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- 03 STRIP AND PREPARE CASING, STOOL, AND APRON TO RECEIVE NEW COAT OF PAINT TO MATCH EXISTING. PATCH/REPAIR CRACKS AND HOLES WITH PUTTY. ANY ROTTED COMPONENTS TO BE REPLACED WITH WOOD, IN-KIND, MATCHING SIZE AND SPECIES.
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- 14 DAMAGED RECESSED PANELS TO BE REPLACED IN-KIND TO MATCH EXISTING IN SIZE AND SPECIES; SAND, PREP, AND PAINT NEW WOOD SURFACES TO MATCH EXISTING WOOD SURFACES
- 15 CONSTRUCT REPLICA WINDOW MATCH ADJACENT WOOD
- WINDOWS INKIND, SIZE AND SPECIES. 16 NEW TEMPERED GLASS, MATCH EXISTING IN-KIND.
- 17 NEW HARDWARE, MATCH EXISTING IN-KIND.
- DEMO PLYWOOD AND DUCT WORK TO REVEAL JAIL BARS; CAREFULLY REMOVE ALL EXPOSED SPRAY FOAM AND MASTIC



he i BEFORE COMMENCING ANY WORK AND REQUEST CLARIFICATION.

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11/01/24

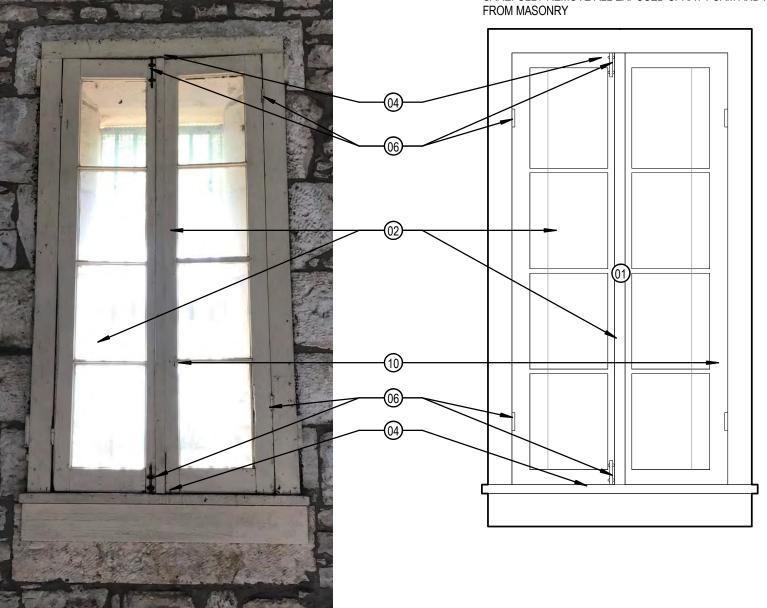JAIL 881 **DETAILS REHABILITATION**

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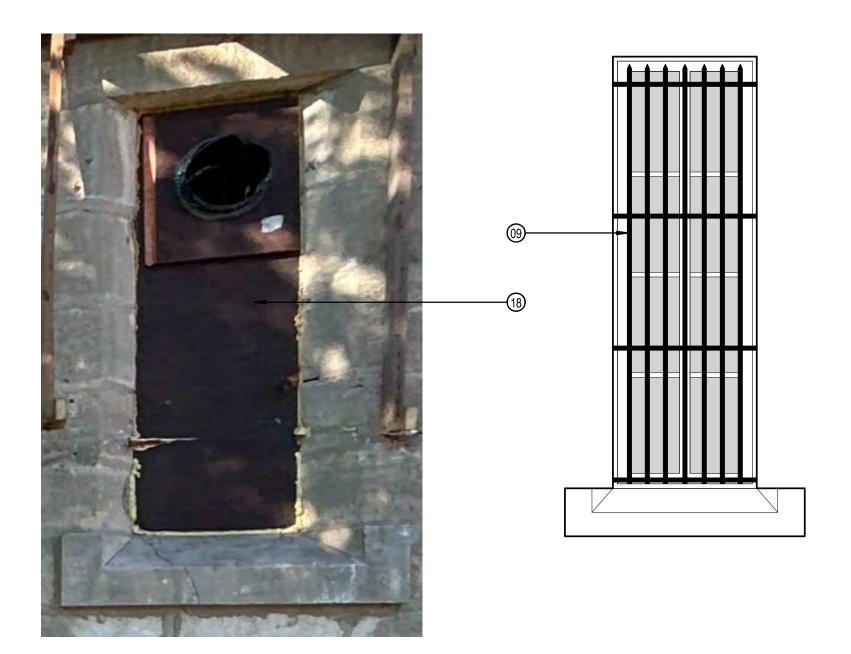
COUNTY VISITOR BANDERA SHEET TITLE: WINDOW

PROJECT NO: 2301 A1 A REVISIONS DATE


1 RE-ISSUE

11/1/2024

JL-1 EXTERIOR



TYPE B EXTERIOR

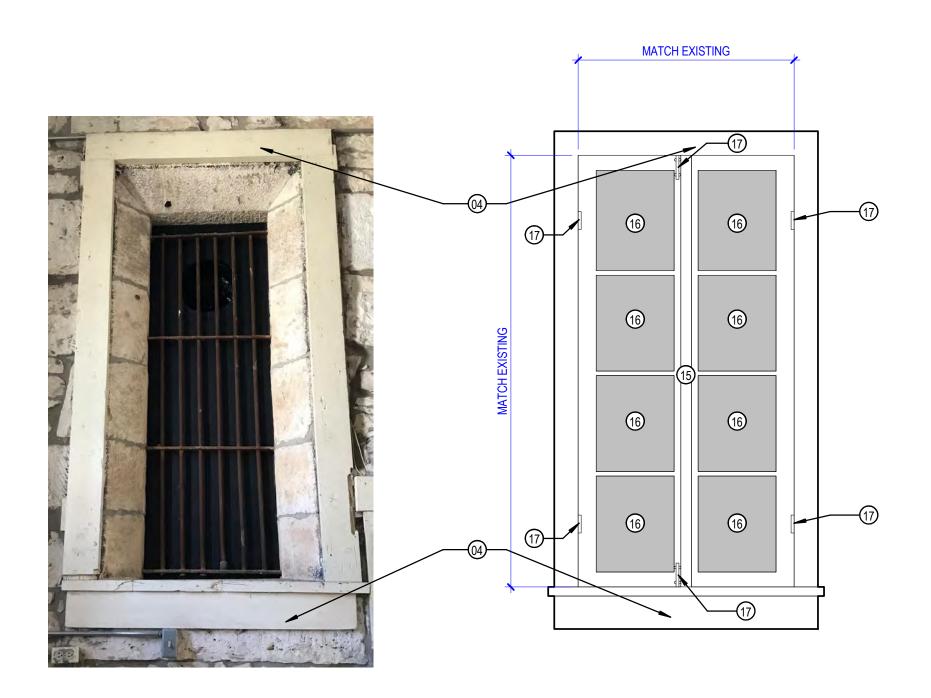


2 TYPE B INTERIOR

3/4" = 1'-0"


DOOR HARDWARE SET ALTERNATE

	HARDWARE	
NUMBER	SET	COMMENTS
C-100	LS-1	[1,2]
C-101	LS-1	[1,2]
C-102	LS-1	[1,2]
J-100	LS-2	[1,3]

LEGEND	COMMENTS		
HARDWARE TYPES	[1]	REPLACE EXISTING HARDWARE PER SCHEDULE	
LS-1 : LOCKSET; REFER TO SPECS LS-2 : LOCKSET; REFER TO	[2]	PROVIDE MASTER KEY FOR ALL LS-1 HARDWARE	
SPECS	[3]	PROVIDE MASTER KEY FOR ALL LS-2 HARDWARE	

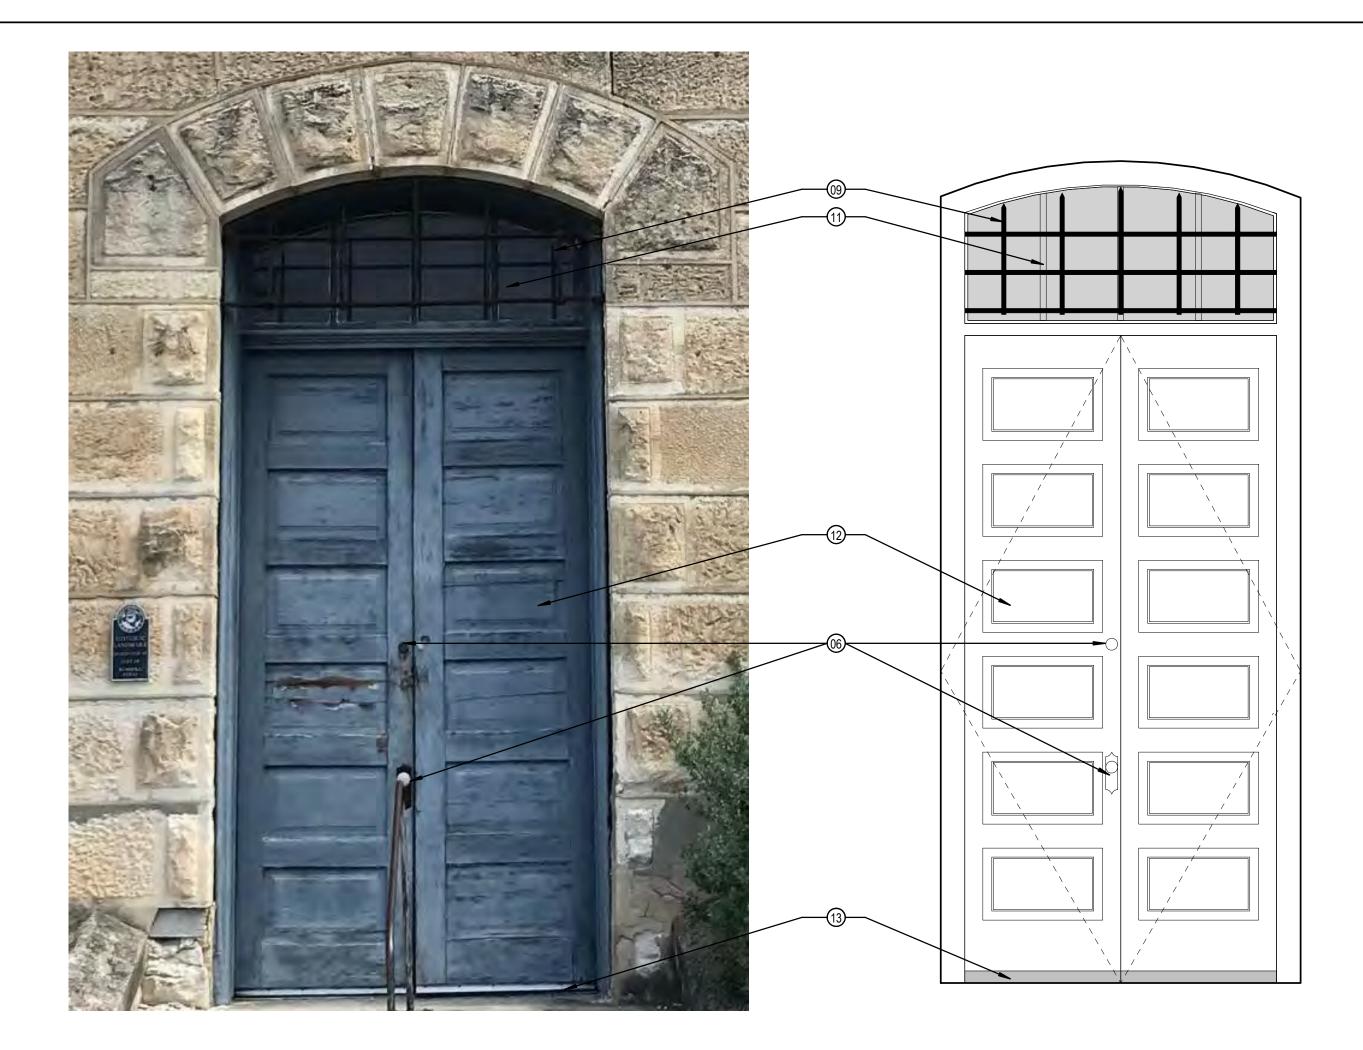

↑ DOOR J100 - EXTERIOR ELEVATION

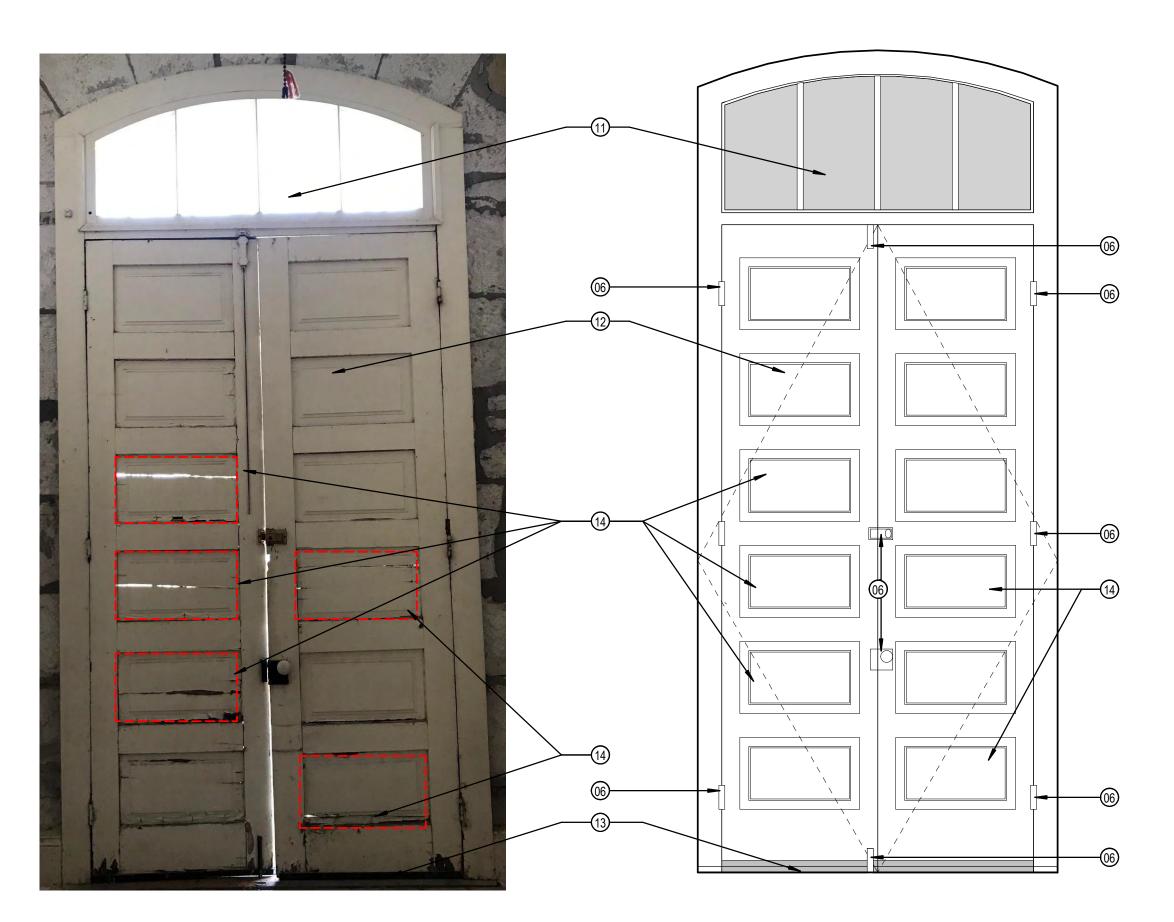

DOOR J100 - INTERIOR ELEVATION

3/4" = 1'-0"

GENERAL NOTES

- 1. IMMEDIATELY ON DISCOVERY OF THE NEED FOR CLARIFICATION OF THE CONTRACT DOCUMENTS, SUBMIT A REQUEST FOR
- INFORMATION TO ARCHITECT. 2. THESE DOCUMENTS SHOULD NO BE CONSIDERED AS A SURVEY OF EXISTING CONDITIONS. THE GENERAL CONTRACTOR SHALL NOTIFY ARCHITECT IMMEDIATELY OF ANY DISCREPANCIES OR OMISSIONS BETWEEN DOCUMENTS AND FIELD CONDITIONS
- 3. ELEMENTS NOTED WITHIN KEYNOTES ARE BASED UPON VISUAL OBSERVATIONS AT THE TIME OF SURVEY, CONTRACTOR TO VERIFY ANY ADDITIONAL SUBSEQUENT DAMAGE THAT MAY HAVE OCCURED, CONTRACTOR TO ASSUME 30% REPLACEMENT OF ELEMENTS IN-KIND FOR EACH WINDOW FOR PURPOSES OF BID AND VERIFY ON-SITE ANY ELEMENTS THAT ARE ROTTED, BROKEN SPLIT OR MISSING SHALL BE REPLACED IN-KIND.
- 4. FIELD VERIFY ALL EXISTING DIMENSIONS, ELEVATIONS, & CONDITIONS PRIOR TO COMMENCEMENT OF WORK.
- 5. ALL DIMENSIONS ARE TO FACE OF MATERIAL UNLESS NOTED 6. CHIPS OR GAPS IN WOOD UNDER ONE-INCH MAY BE REPAIRED
- WITH WOOD FILLER. SAND, PREP & PAINT TO MATCH. 7. ANY BROKEN PANES OF GLASS TO BE REPLACED & REGLAZED
- 8. APPLY A CONTINUOUS BEAD OF CLEAR SEALANT AROUND PERIMETER OF EACH WINDOW FRAME.
- 9. TYPE A WINDOWS TO RECEIVE HARDWARE MATCHING HISTORIC SECOND FLOOR WINDOWS IN-KIND. SCREW FRAMES SHUT FROM INTERIOR SIDE AFTERWARDS.

KEYNOTES

- 01 REPLACE ROTTED COMPONANTS WITHIN FRAME AS NEEDED WIT WOOD, IN-KIND, MATCHING SIZE, SPECIES, AND PROFILE. SAND, PREP, AND PAINT ALL WOOD SURFACES.
- 02 STRIP AND PREPARE STILES, MULLIONS, AND RAILS TO RECEIVE NEW COAT OF PAINT. PATCH/REPAIR CRACKS AND HOLES WITH PUTTY. ANY ROTTED COMPONENTS TO BE REPLACED WITH WOOD, IN-KIND, MATCHING SPECIES.
- 03 STRIP AND PREPARE CASING, STOOL, AND APRON TO RECEIVE NEW COAT OF PAINT TO MATCH EXISTING. PATCH/REPAIR CRACKS AND HOLES WITH PUTTY. ANY ROTTED COMPONENTS TO BE REPLACED WITH WOOD, IN-KIND, MATCHING SIZE AND
- 04 STRIP AND PREPARE WINDOW FRAMES, SILLS, SASHES, AND TRIM TO RECEIVE NEW PAINT. PATCH/REPAIR CRACKS AND HOLES WITH PUTTY. ANY ROTTED COMPONENTS TO BE REPLACED WITH WOOD, IN-KIND, MATCHING SIZE AND SPECIES.
- 05 REPAIR DAMAGED STILES.
- 06 STRIP AND RECONDITION HARDWARE FOR REUSE.
- REPLACE MISSING CASING WITH WOOD, IN-KIND, MATCHING SIZE 08 REPLACE BROKEN GLASS, REPLACE WITH NEW TEMPERED GLASS
- 09 SODA BLAST CLEAN ALL JAIL WINDOW BARS DOWN TO BARE METAL, THEN APPLY EPOXY PRIMER, THEN PAINT
- 10 STRIP AND PREPARE INTERIOR WINDOW SCREEN TO RECEIVE NEW PAINT. PATCH/REPAIR CRACKS AND HOLES WITH PUTTY. ANY ROTTED COMPONENTS TO BE REPLACED WITH WOOD, IN-KIND, MATCHING SIZE AND SPECIES. REPLACE GLASS PANES IN-KIND.
- REPAIR EXISTING TRANSOM FRAME / GLASS; REMOVE EXISTING PANES, REPLACE WITH NEW TEMPERED GLASS, IN-KIND. REPLACE DAMAGED WOOD COMPONANTS, IN-KIND, AS NEEDED. SAND, PREP, AND PAINT ALL WOOD SURFACES.
- 12 REPAIR / REPLACE DAMAGED DOOR COMPONENTS AS NEEDED WITH WOOD, IN-KIND, MATCHING SIZE AND SPECIES. SAND, PREP, AND PAINT ALL WOOD SURFACES.
- 13 REPLACE DAMAGED, DETERIORATED, OR MISSING
- WEATHERSTRIPPING AND INSTALL ADA METAL THRESHOLD. DAMAGED RECESSED PANELS TO BE REPLACED IN-KIND TO MATCH EXISTING IN SIZE AND SPECIES; SAND, PREP, AND PAINT NEW WOOD SURFACES TO MATCH EXISTING WOOD SURFACES
- 15 CONSTRUCT REPLICA WINDOW MATCH ADJACENT WOOD WINDOWS INKIND, SIZE AND SPECIES.
- 16 NEW TEMPERED GLASS, MATCH EXISTING IN-KIND.
- 17 NEW HARDWARE, MATCH EXISTING IN-KIND.
- DEMO PLYWOOD AND DUCT WORK TO REVEAL JAIL BARS; CAREFULLY REMOVE ALL EXPOSED SPRAY FOAM AND MASTIC

he in the second BEFORE COMMENCING ANY WORK AND REQUEST CLARIFICATION.

eck c T s



11/01/24

JAIL

2

DETAILS

REHABILITATION

SHEET TITLE: DOOR

11/1/2024

CENTER

COUNTY VISITOR

BANDERA

PROJECT NO: 2301 A1

A REVISIONS DATE

1 RE-ISSUE

SHEET NO: